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	FENTON	762-764 FOREST ROAD & PROSPECT ROAD PEAK
	Project PROPOSED HOSTEL DEVELOPMENT	Drawing Title SITE PLAN
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- LINE OF EXISTING TREES TO BE REMOVED TYPICALLY SHOWN

### BASIX NOTES - CERITICATE No. 1164274M\_03

The proposed Development has achieved the BASIX Water Target of 40%.

The water usage of the development is calculated based on the number and efficiency of permanent fixtures and appliances such as taps, showerheads and toilet, the dish washer and clothes washing machine.

The size of the rainwater tank and number of connections may have a significant impact on your water score as does the area of gardens and lawns whether or not low water plant species are incorporated.

### Thermal Comfort

The alternative assessment process allows the thermal comfort of a large boarding house development to be assessed at a later stage against the Section J requirements of the National Construction Code (NCC). If a building only contains a large boarding house, and all of the dwellings are Class 3, then a NatHERS assessment is not required for any of the dwellings. If a building contains both a large boarding house and Class 2 apartments (that are not part of the boarding house), then a NatHERS assessment is required for each of the apartments.

The maximum heating load and maximum cooling load for each room are entered into the thermal comfort results table in BASIX as a dummy figure. The department of planning will remove rooms not applicable to NatHERS and replace with an additional comment specifying thermal comfort of the dwelling is to be determined under Section J of the NCC. The Section J report is required to be completed prior to obtaining a construction certificate.

### <u>Energy</u>

The proposed Development has achieved the Energy target of 45% to pass this section. The energy usage of the Development is calculated based on the efficiency of fixed appliances that will be used. This includes the air-conditioning system, hot water system, lighting, exhaust fans, cook top, oven, and clothes drying facilities.

BASIX water inclusions Score 48/40 Fixtures within units Showerheads: Mid flow (>6L but <=7.5L/min) Toilets: 4.0 star Kitchen taps: 5.0 star Bathroom vanity taps: 5.0 star Fixtures within common areas Showerheads: Mid flow (>6L but <=7.5L/min) Toilets: 4.0 star Taps: 5.0 star Fire sprinkler test water No BASIX restriction Common area swimming pool - No greater than 36kL BASIX Energy Inclusions Score 45/45 Hot water system Electric heat pump R0.75 (~32mm) insulation to ring main and supply risers Lift motors All lifts to have gearless traction with VVVF motor Appliances and other efficiency measures within units Refrigerators: 3.5 stars Gas cooktop and electric oven Appliances and other efficiency measures within common areas Clothes washer: 4 star Clothes dryer: 2 stars Common clothes drying line Heating and cooling within units All units to have individual, single phase, reverse cycle air conditioning to living areas, and at least 1 bedroom A minimum efficiency of EER 3.0 – 3.5 is required for cooling; and A minimum efficiency of EER 3.5 - 4.0 is required for heating Artificial lighting within units All light fittings within each room are to have LED fixtures installed Ventilation within units Bathroom: individual fan, ducted to roof or façade – manual on/off switch Kitchen range hood: Individual fan, ducted to roof or façade – manual on/off switch Ventilation to common areas Car park area – supply and exhaust air with a carbon monoxide monitor & VSD fan Garbage rooms – Exhaust air, running continuously Plant – Supply only, interlocked to light Indoor pool – Air conditioning system, controlled Community room – Air conditioning system, controlled Change room – Supply only, continuous Gym – Air conditioning system, controlled Laundry - Exhaust only, continuous WC - Exhaust only, interlocked to light Foyer/Breezeway – Naturally ventilated Artificial lighting to common areas Car park area - Light emitting diodes (LEDs) with motion sensors Lifts – Light emitting diodes (LEDs) connected to lift call button Garbage rooms – Light emitting diodes (LEDs) with motion sensor Plant – Light emitting diodes (LEDs) with manual on / manual off switch Indoor pool – Light emitting diodes (LEDs) with manual on / manual off switch Community room – Light emitting diodes (LEDs) with manual on / manual off switch Change room – Light emitting diodes (LEDs) with manual on / timer off Gym – Light emitting diodes (LEDs) with manual on / timer off Laundry - Light emitting diodes (LEDs) with manual on / manual off switch WC – Light emitting diodes (LEDs) with manual on / manual off switch Foyer/breezeway – Light emitting diodes (LEDs) with daylight and motion sensors Common area swimming pool Heating system: Electric heat pump Pump controlled by a timer Alternative energy supply Photovoltaic system: 19kW

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	PO BOX 214 Oatley NSW	E mail@innovate.com.au w www.innovate.com.au	Job Number	OCT 2020	Sheet	
	REGISTERED ARCHITECTS Nominated Architect Cameron Jones 7143	Architects	2699		01	FENTON APPLICA

VIEWS



IMAGE 1 VIEW OF SUBJECT SITE (D.P. 12997) FROM PROSPECT STREET



IMAGE 2 VIEW OF SUBJECT SITE (D.P. 659072) FROM PROSPECT STREET



IMAGE 3 VIEW OF SUBJECT SITE (D.P. 659072) FROM PROSPECT STREET



IMAGE 4 VIEW OF SUBJECT SITE (D.P. 659072) FROM FOREST ROAD



VIEW OF SUBJECT SITE (D.P. 659072) FROM FOREST ROAD



IMAGE 6 VIEW OF SUBJECT SITE (D.P. 659072) FROM FOREST ROAD

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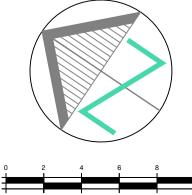
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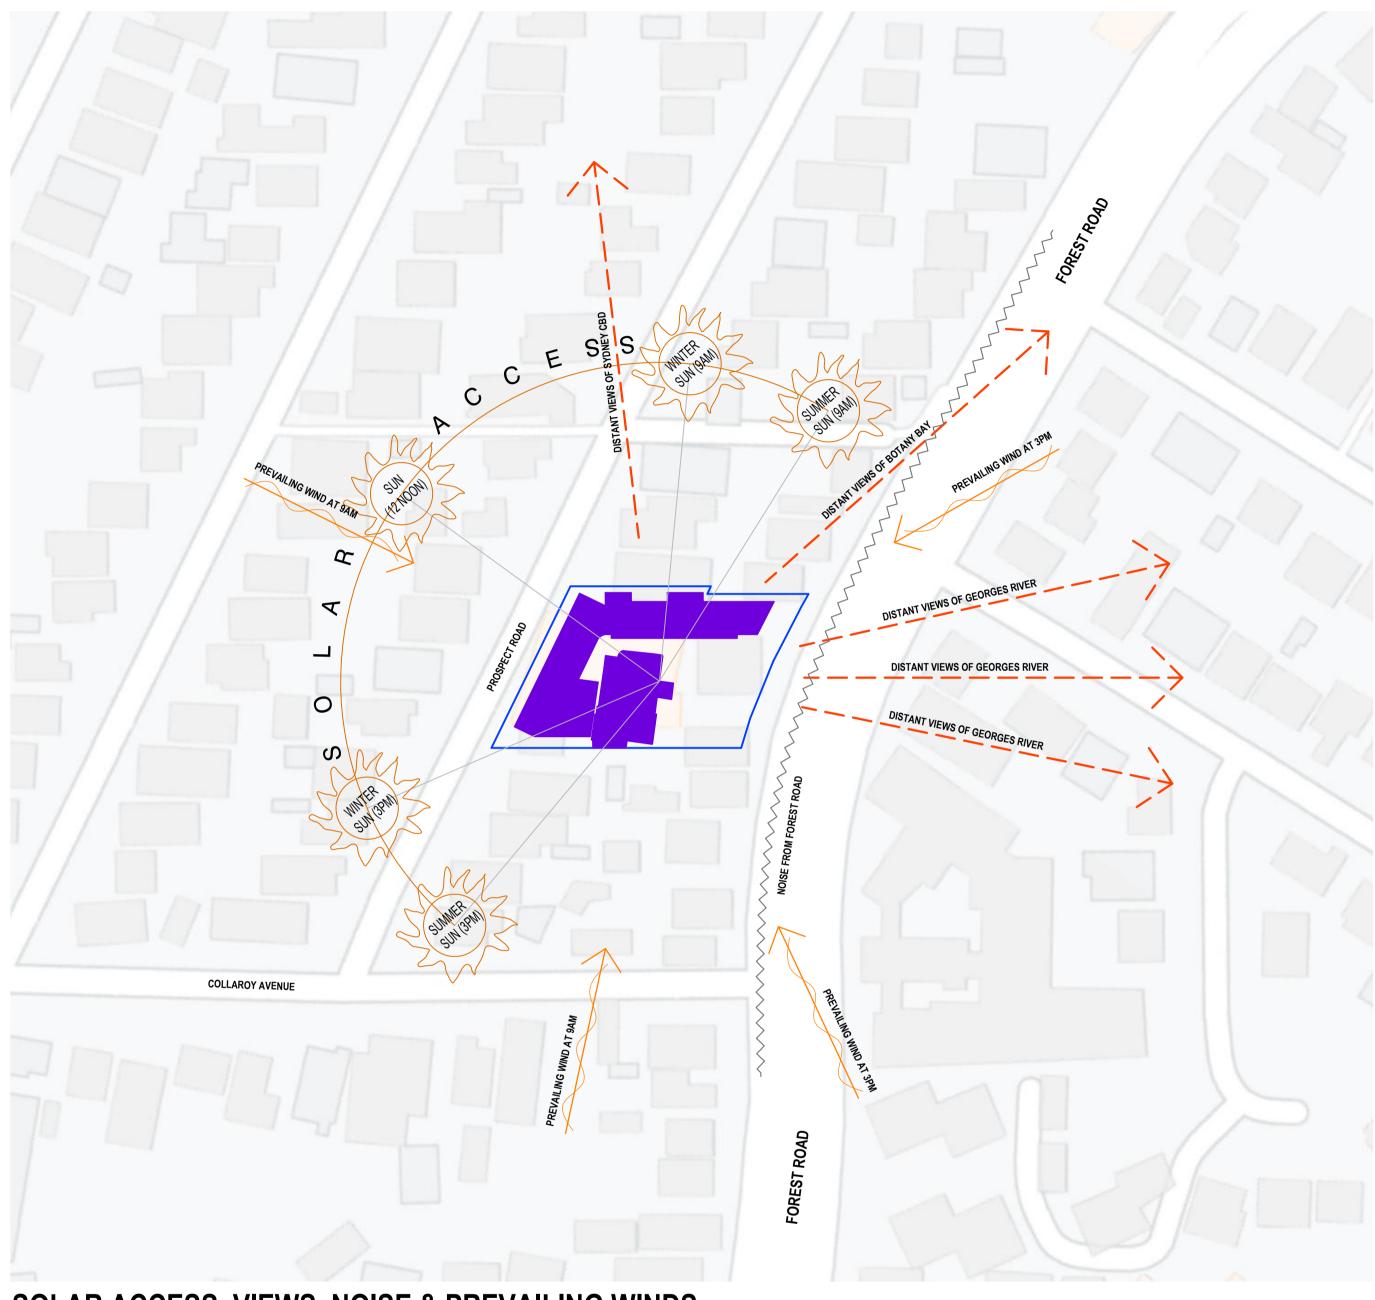


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DATE INT.

FENTON	762-764 FOREST ROAD & 21 PROSPECT ROAD PEAKHURS
oject	Drawing Title
PROPOSED HOSTEL DEVELOPMENT	SITE ANALYSIS DIAGRAM

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RST	Suite 9b, 32 Frederick Street Oatley NSW 2223 PO BOX 214 Oatley NSW	<ul> <li>T 02 9585 1855</li> <li>F 02 9585 1844</li> <li>E mail@innovate.com.au</li> <li>w www.innovate.com.au</li> </ul>		Check GJ Date OCT 2020	Issue
	REGISTERED ARCHITECTS Nominated Architect Cameron Jones 7143	Architects	Job Number 2699		Sheet SA01



## SOLAR ACCESS, VIEWS, NOISE & PREVAILING WINDS

### KEY

SITE BOUNDARY — PROPOSAL PREVAILING WIND  $- - - \rightarrow$  VIEWS

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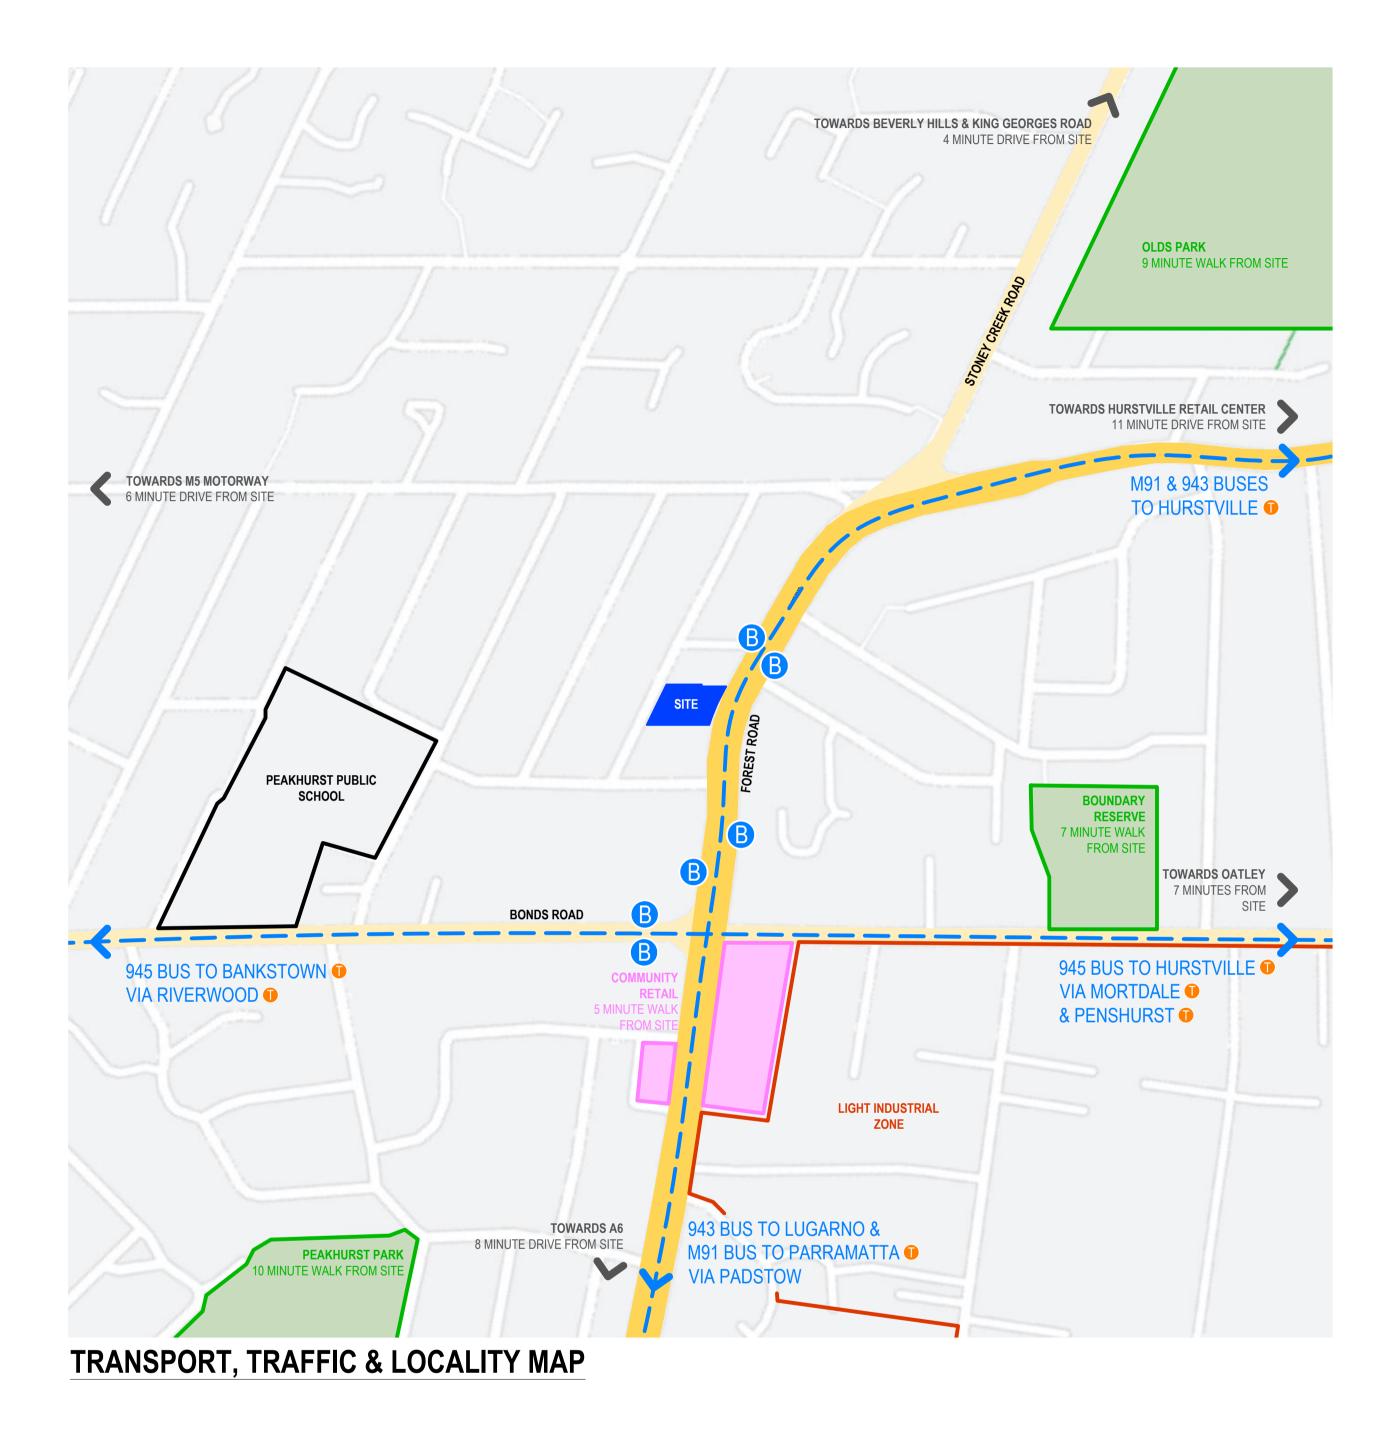
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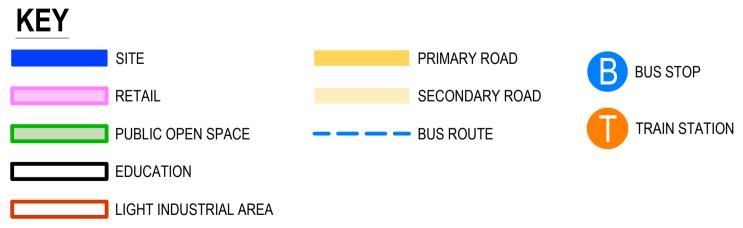
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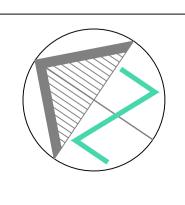
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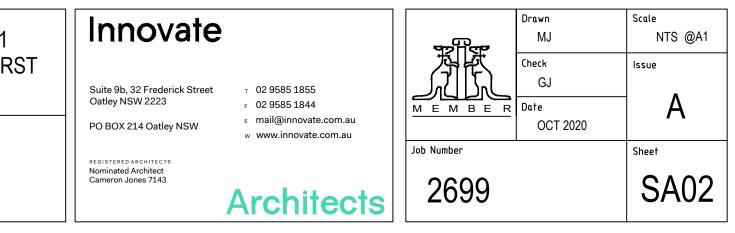




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Client FENTON	Address 762-764 FOREST ROAD & 21 PROSPECT ROAD PEAKHURS
Project PROPOSED HOSTEL DEVELOPMENT	Drawing Title AREA ANALYSIS DIAGRAMS





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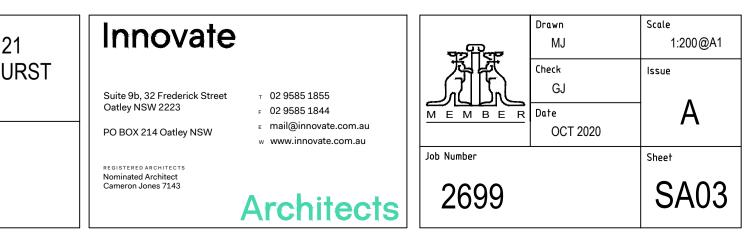
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## 2 PROPOSED STREETSCAPE ANALYSIS SCALE 1 : 200

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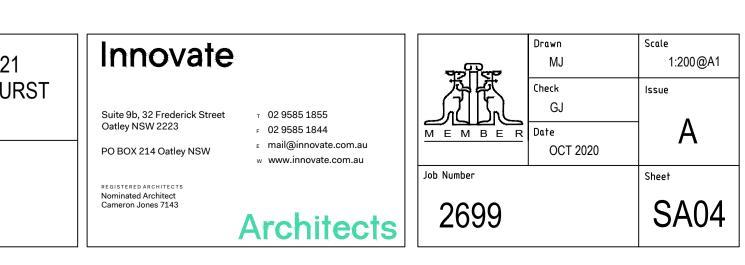
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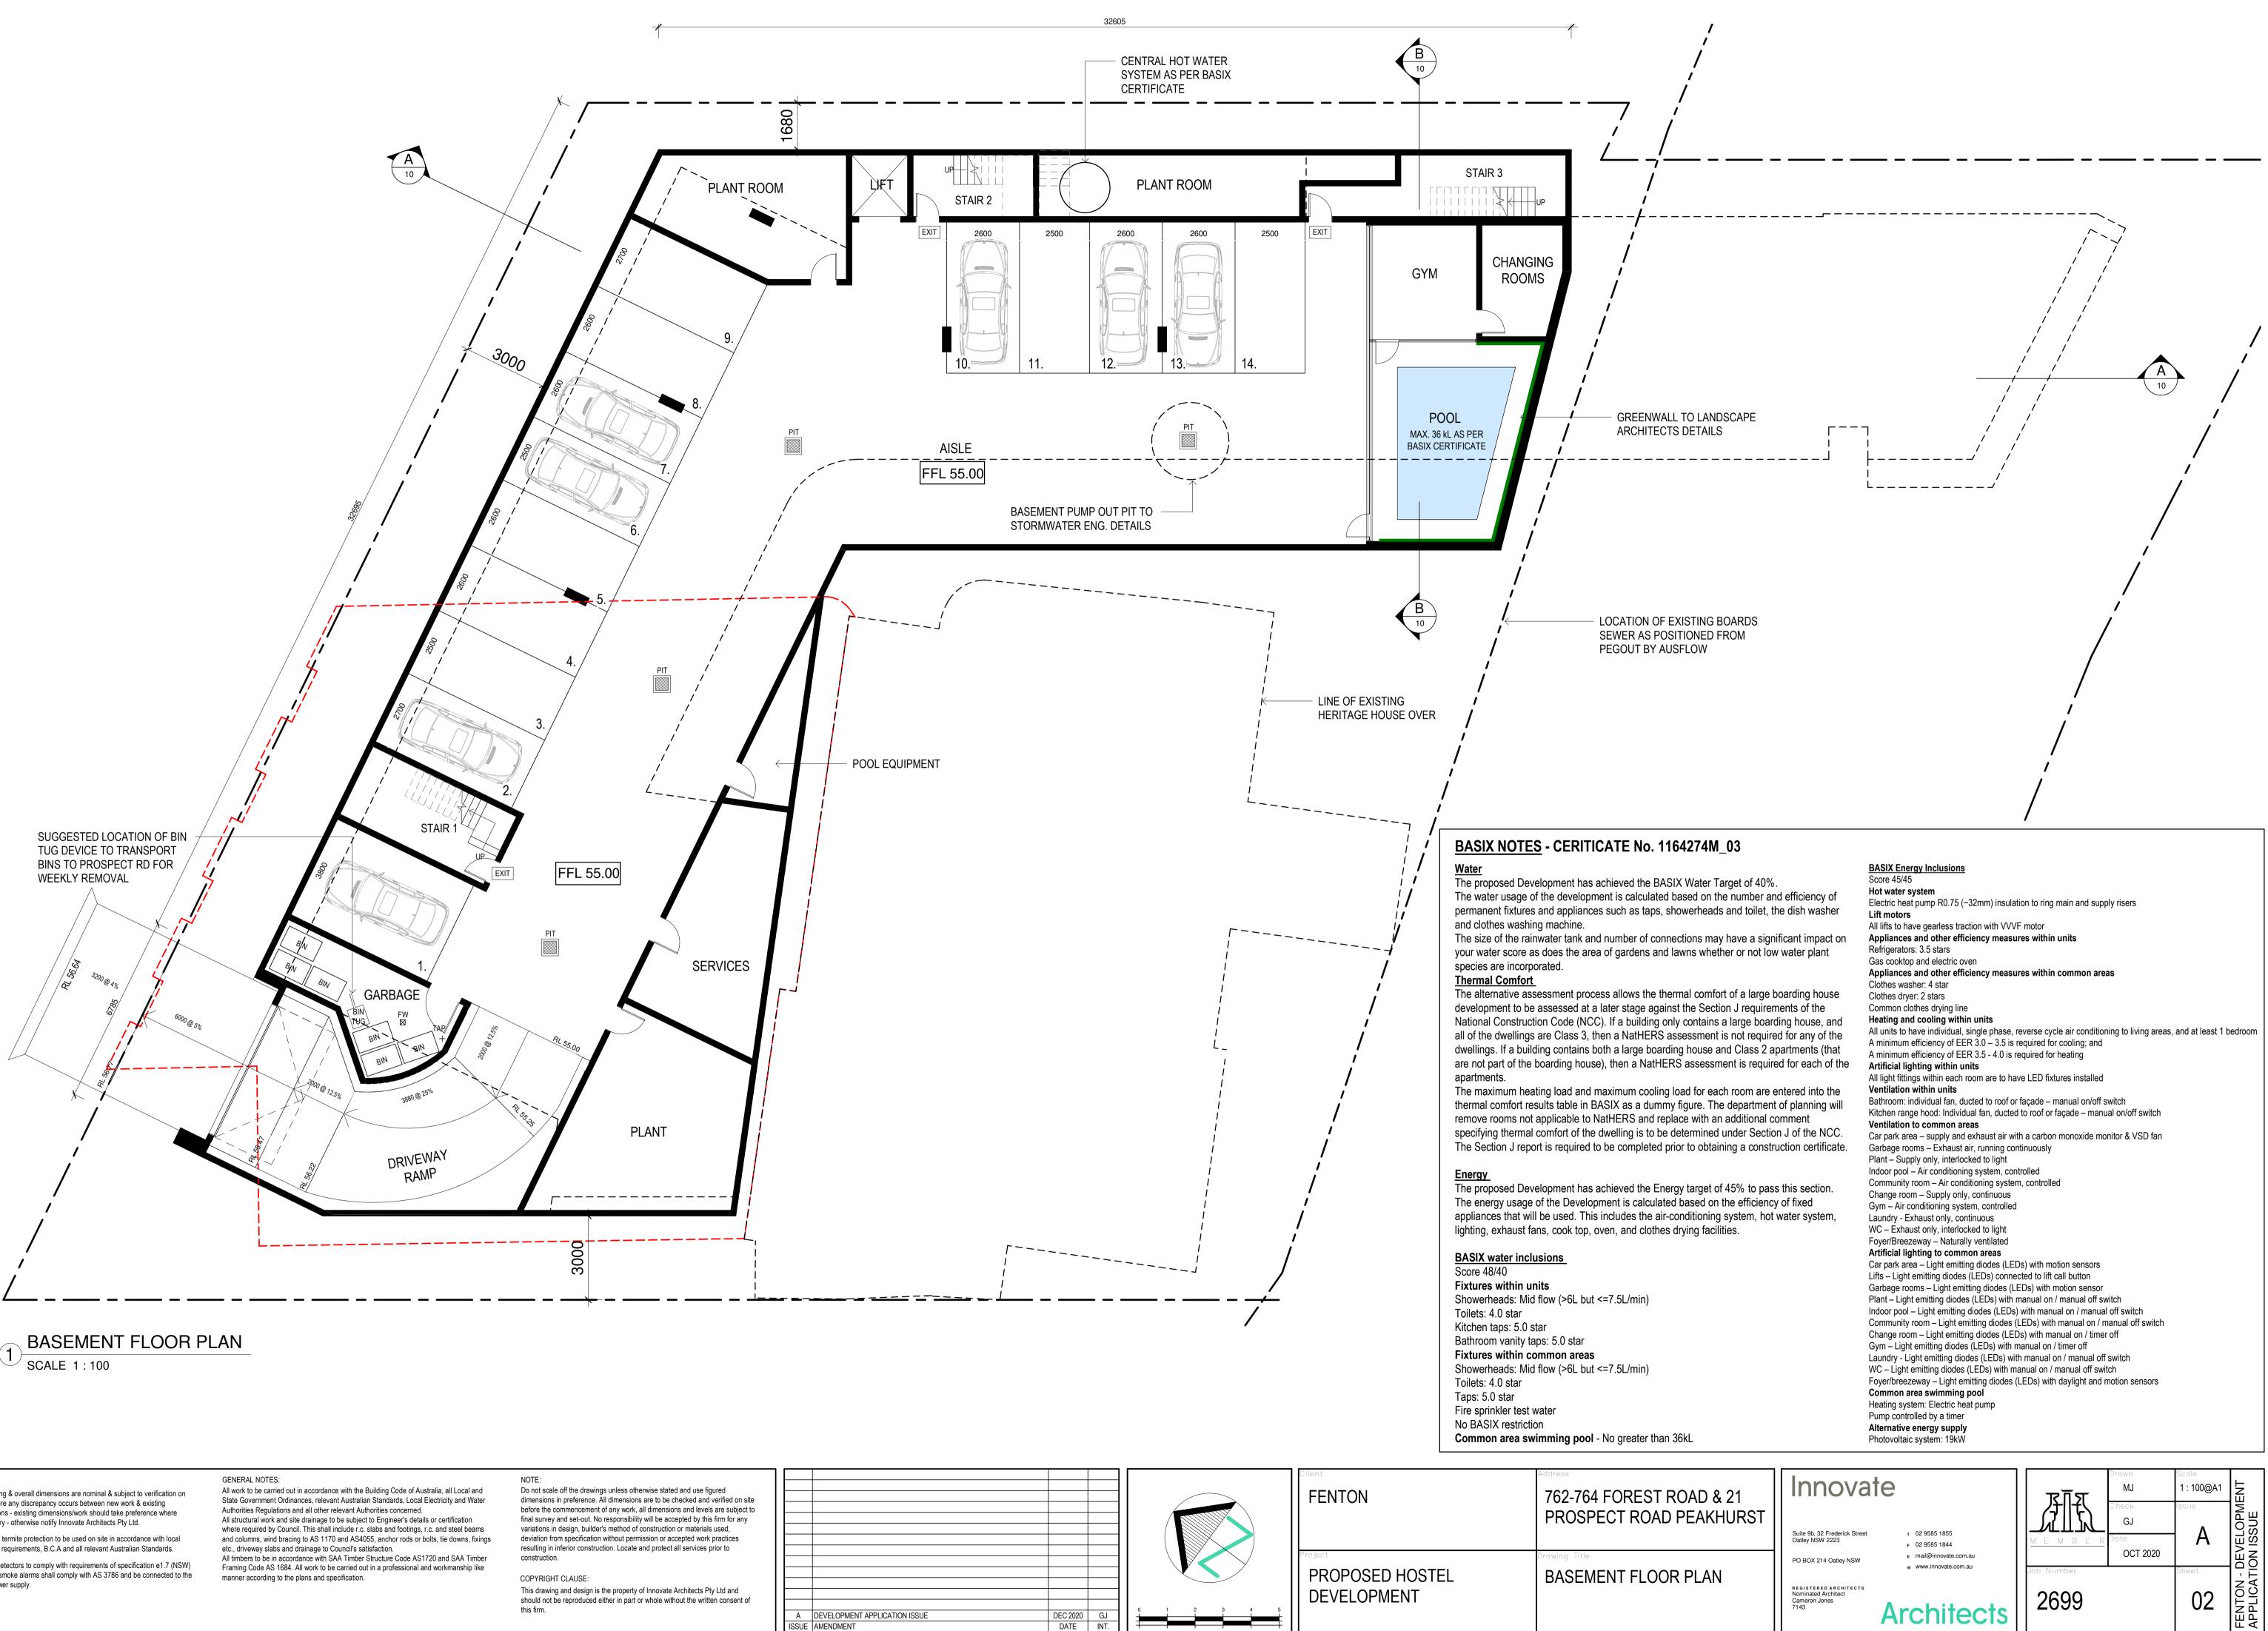
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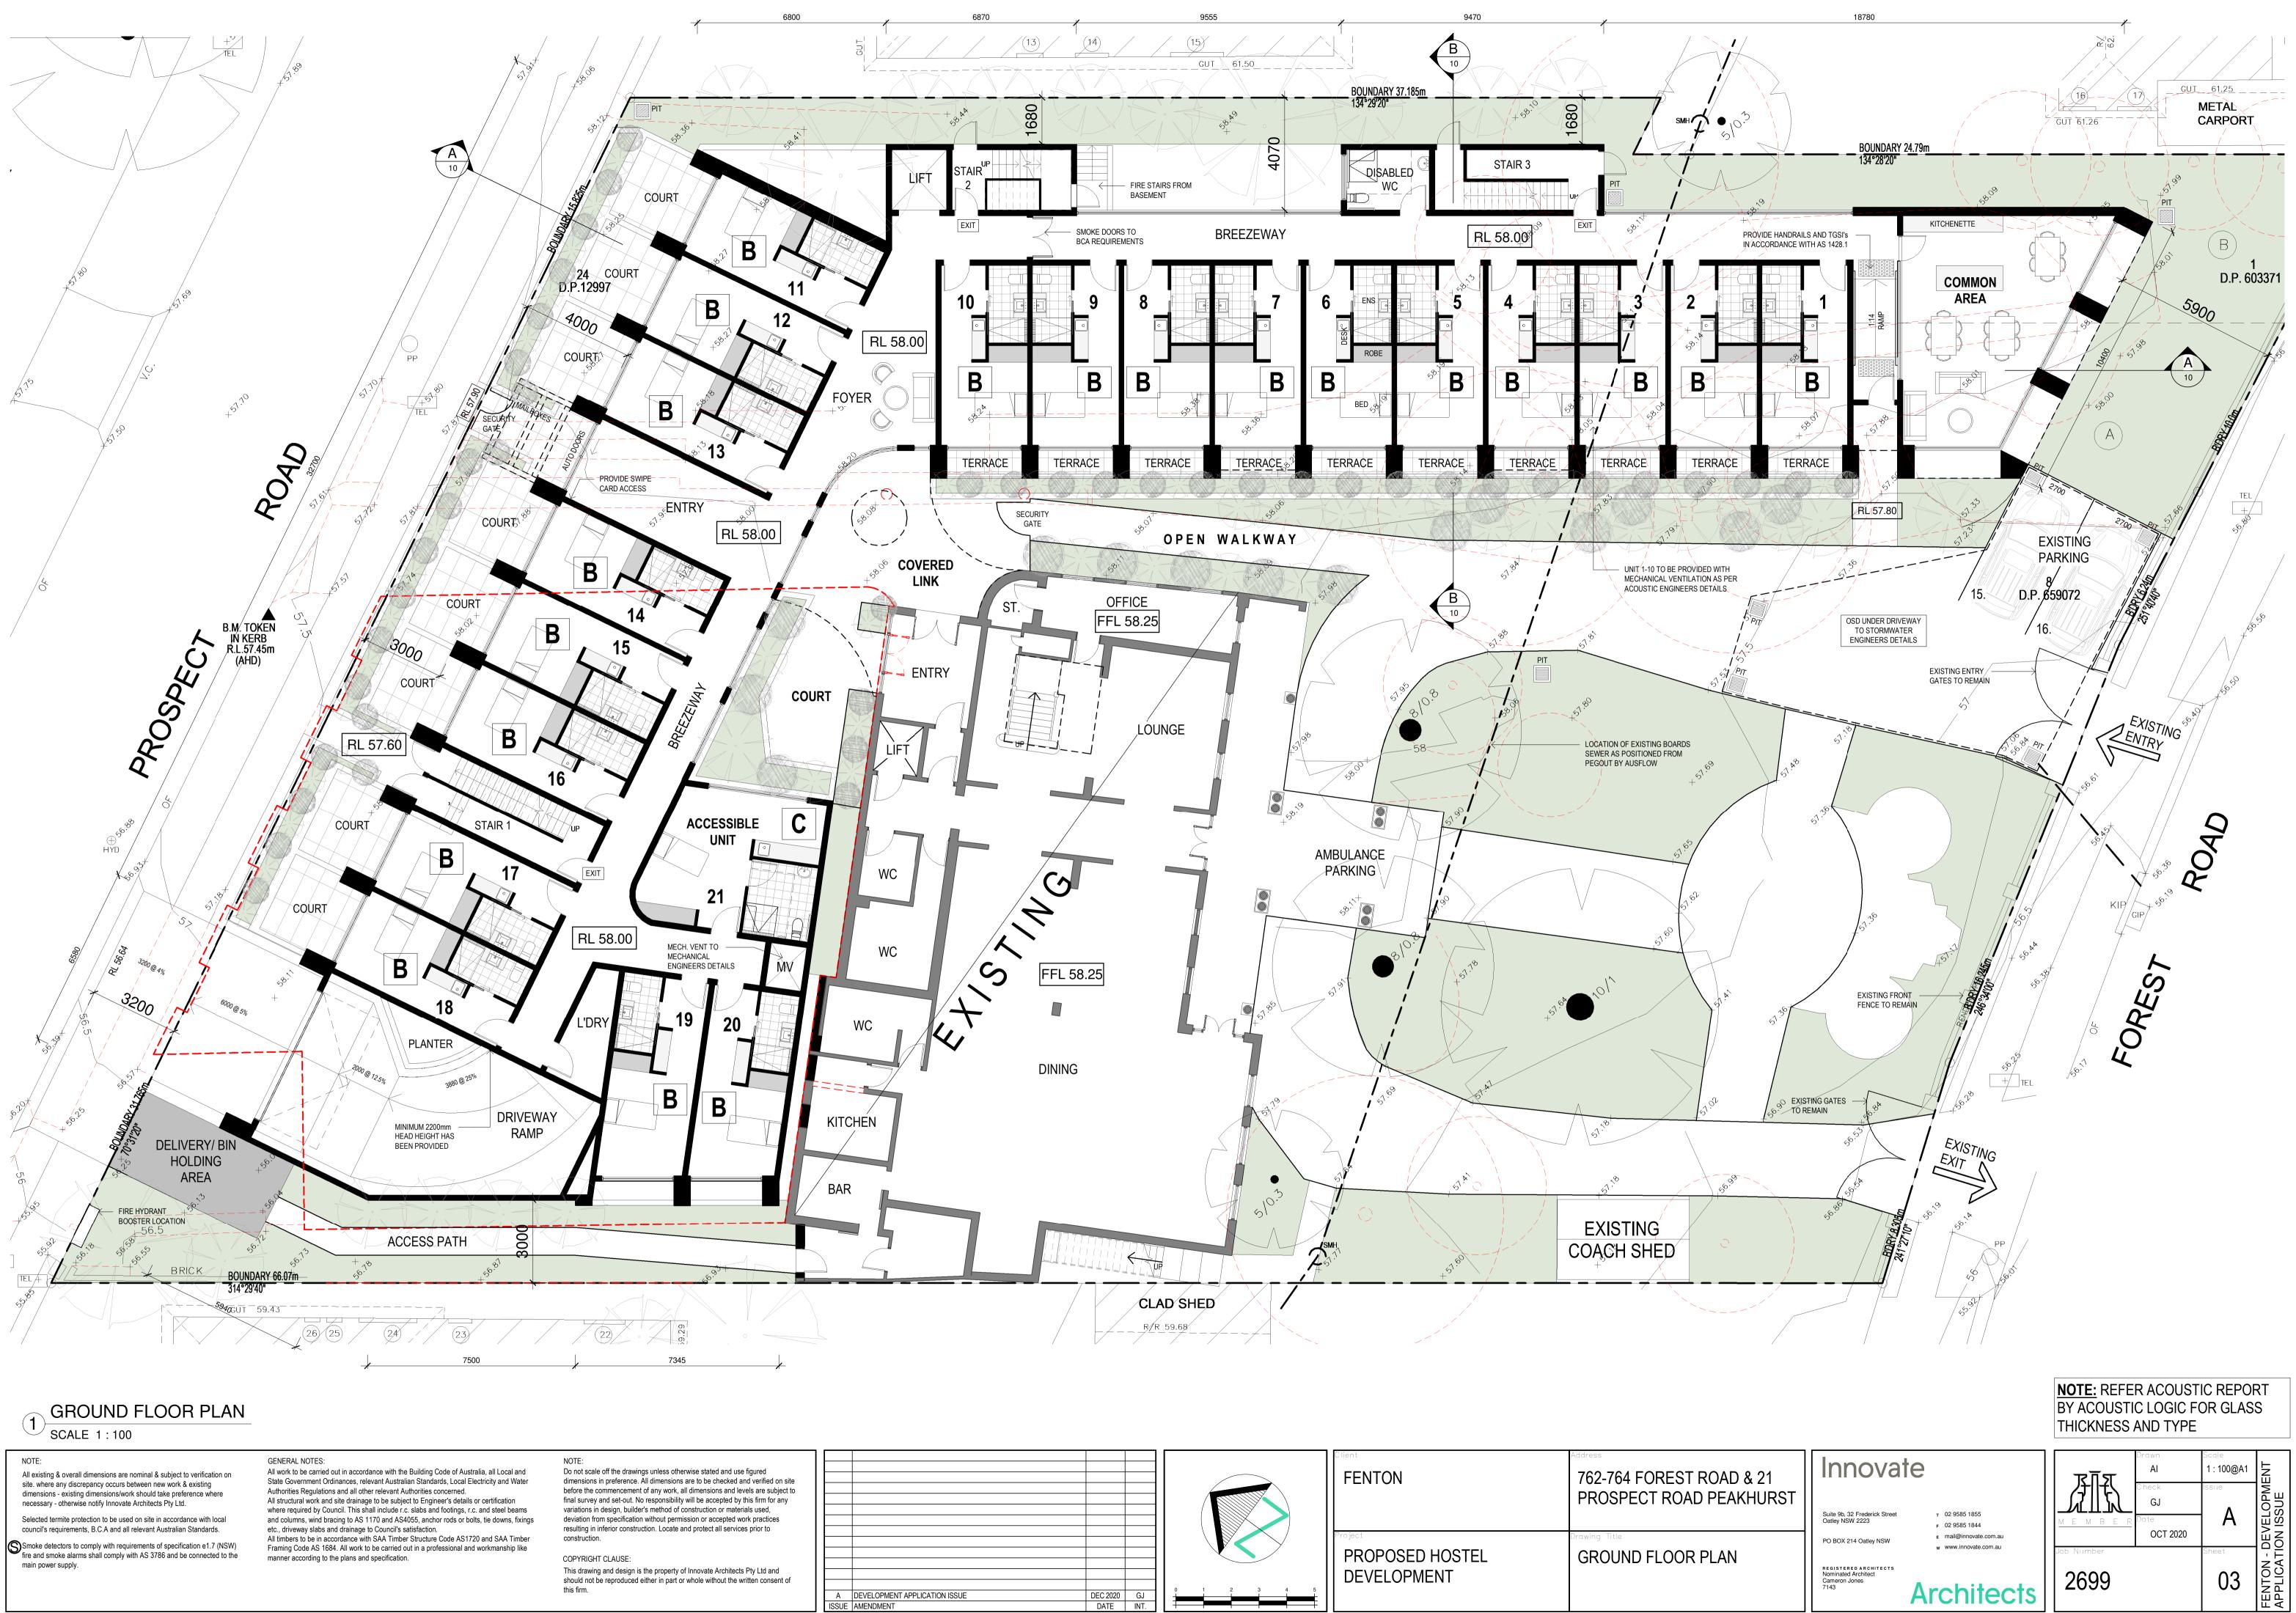
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	MEMBER	Date OCT 2020
	Job Number 2699	
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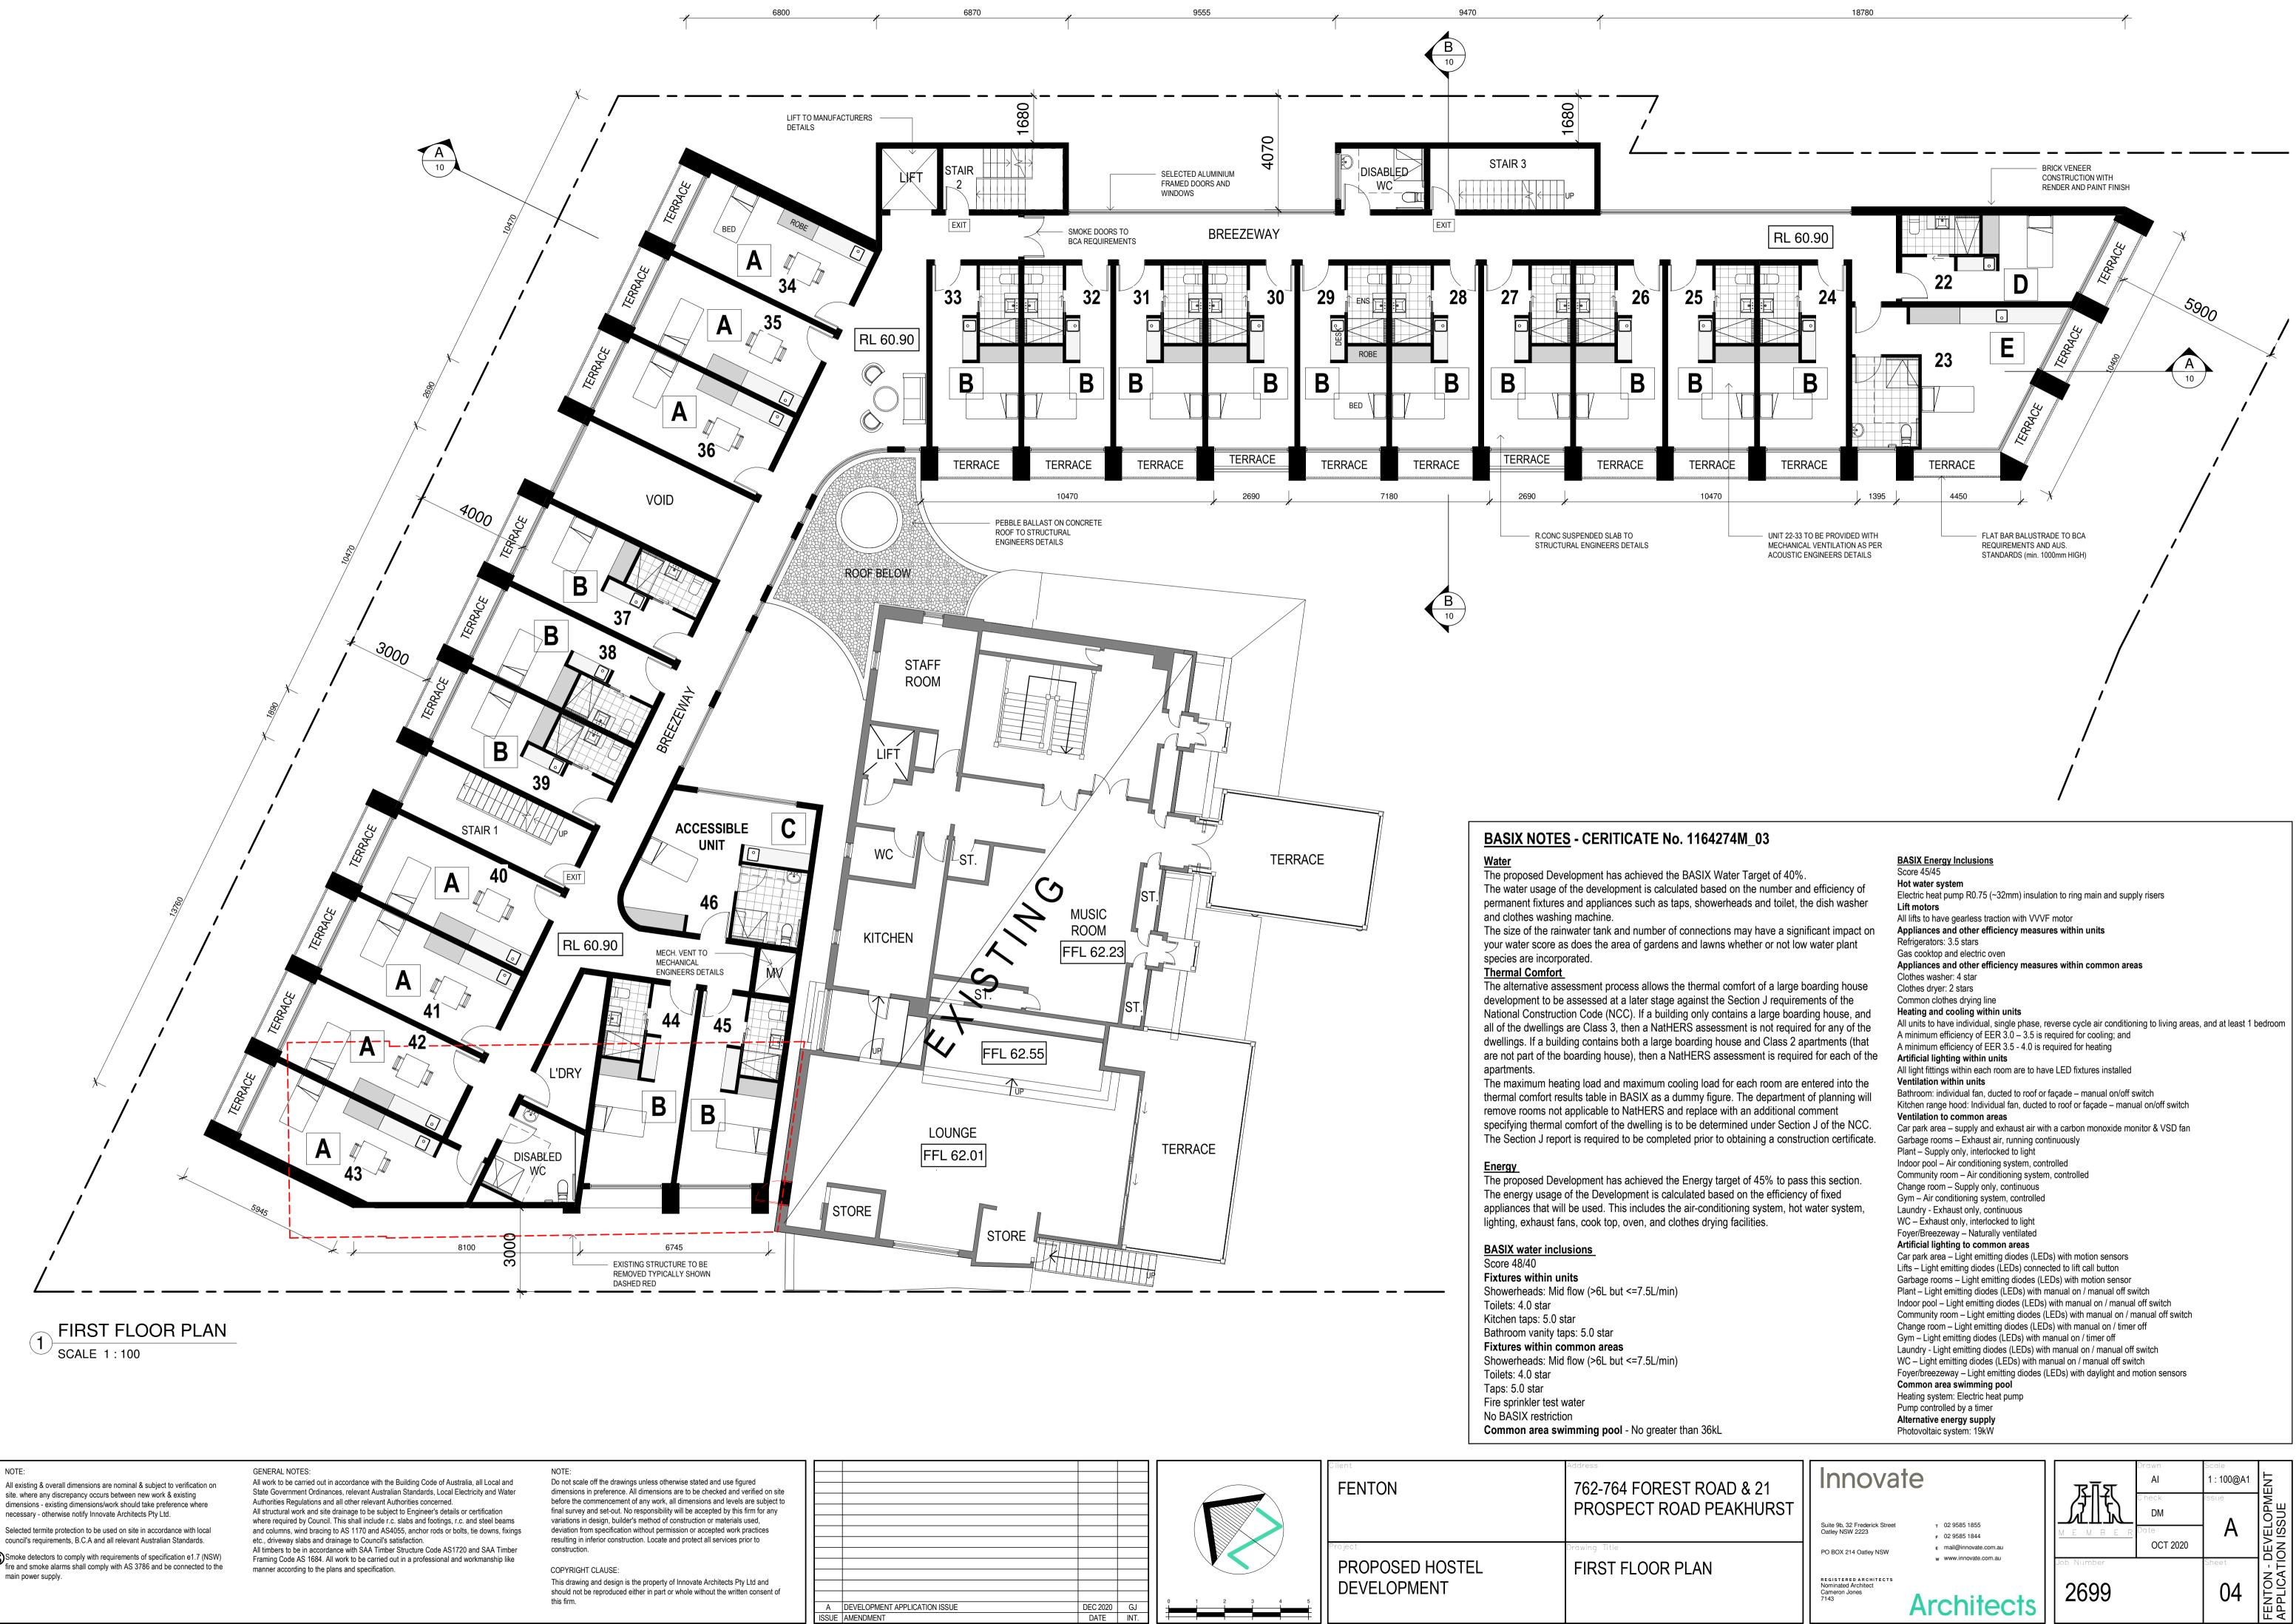
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A     DEVELOPMENT APPLICATION ISSUE       ISSUE     AMENDMENT	GJ INT.	Project PROPOSED HOSTEL DEVELOPMENT	Drawing Title GROUND FLOOR PLAN

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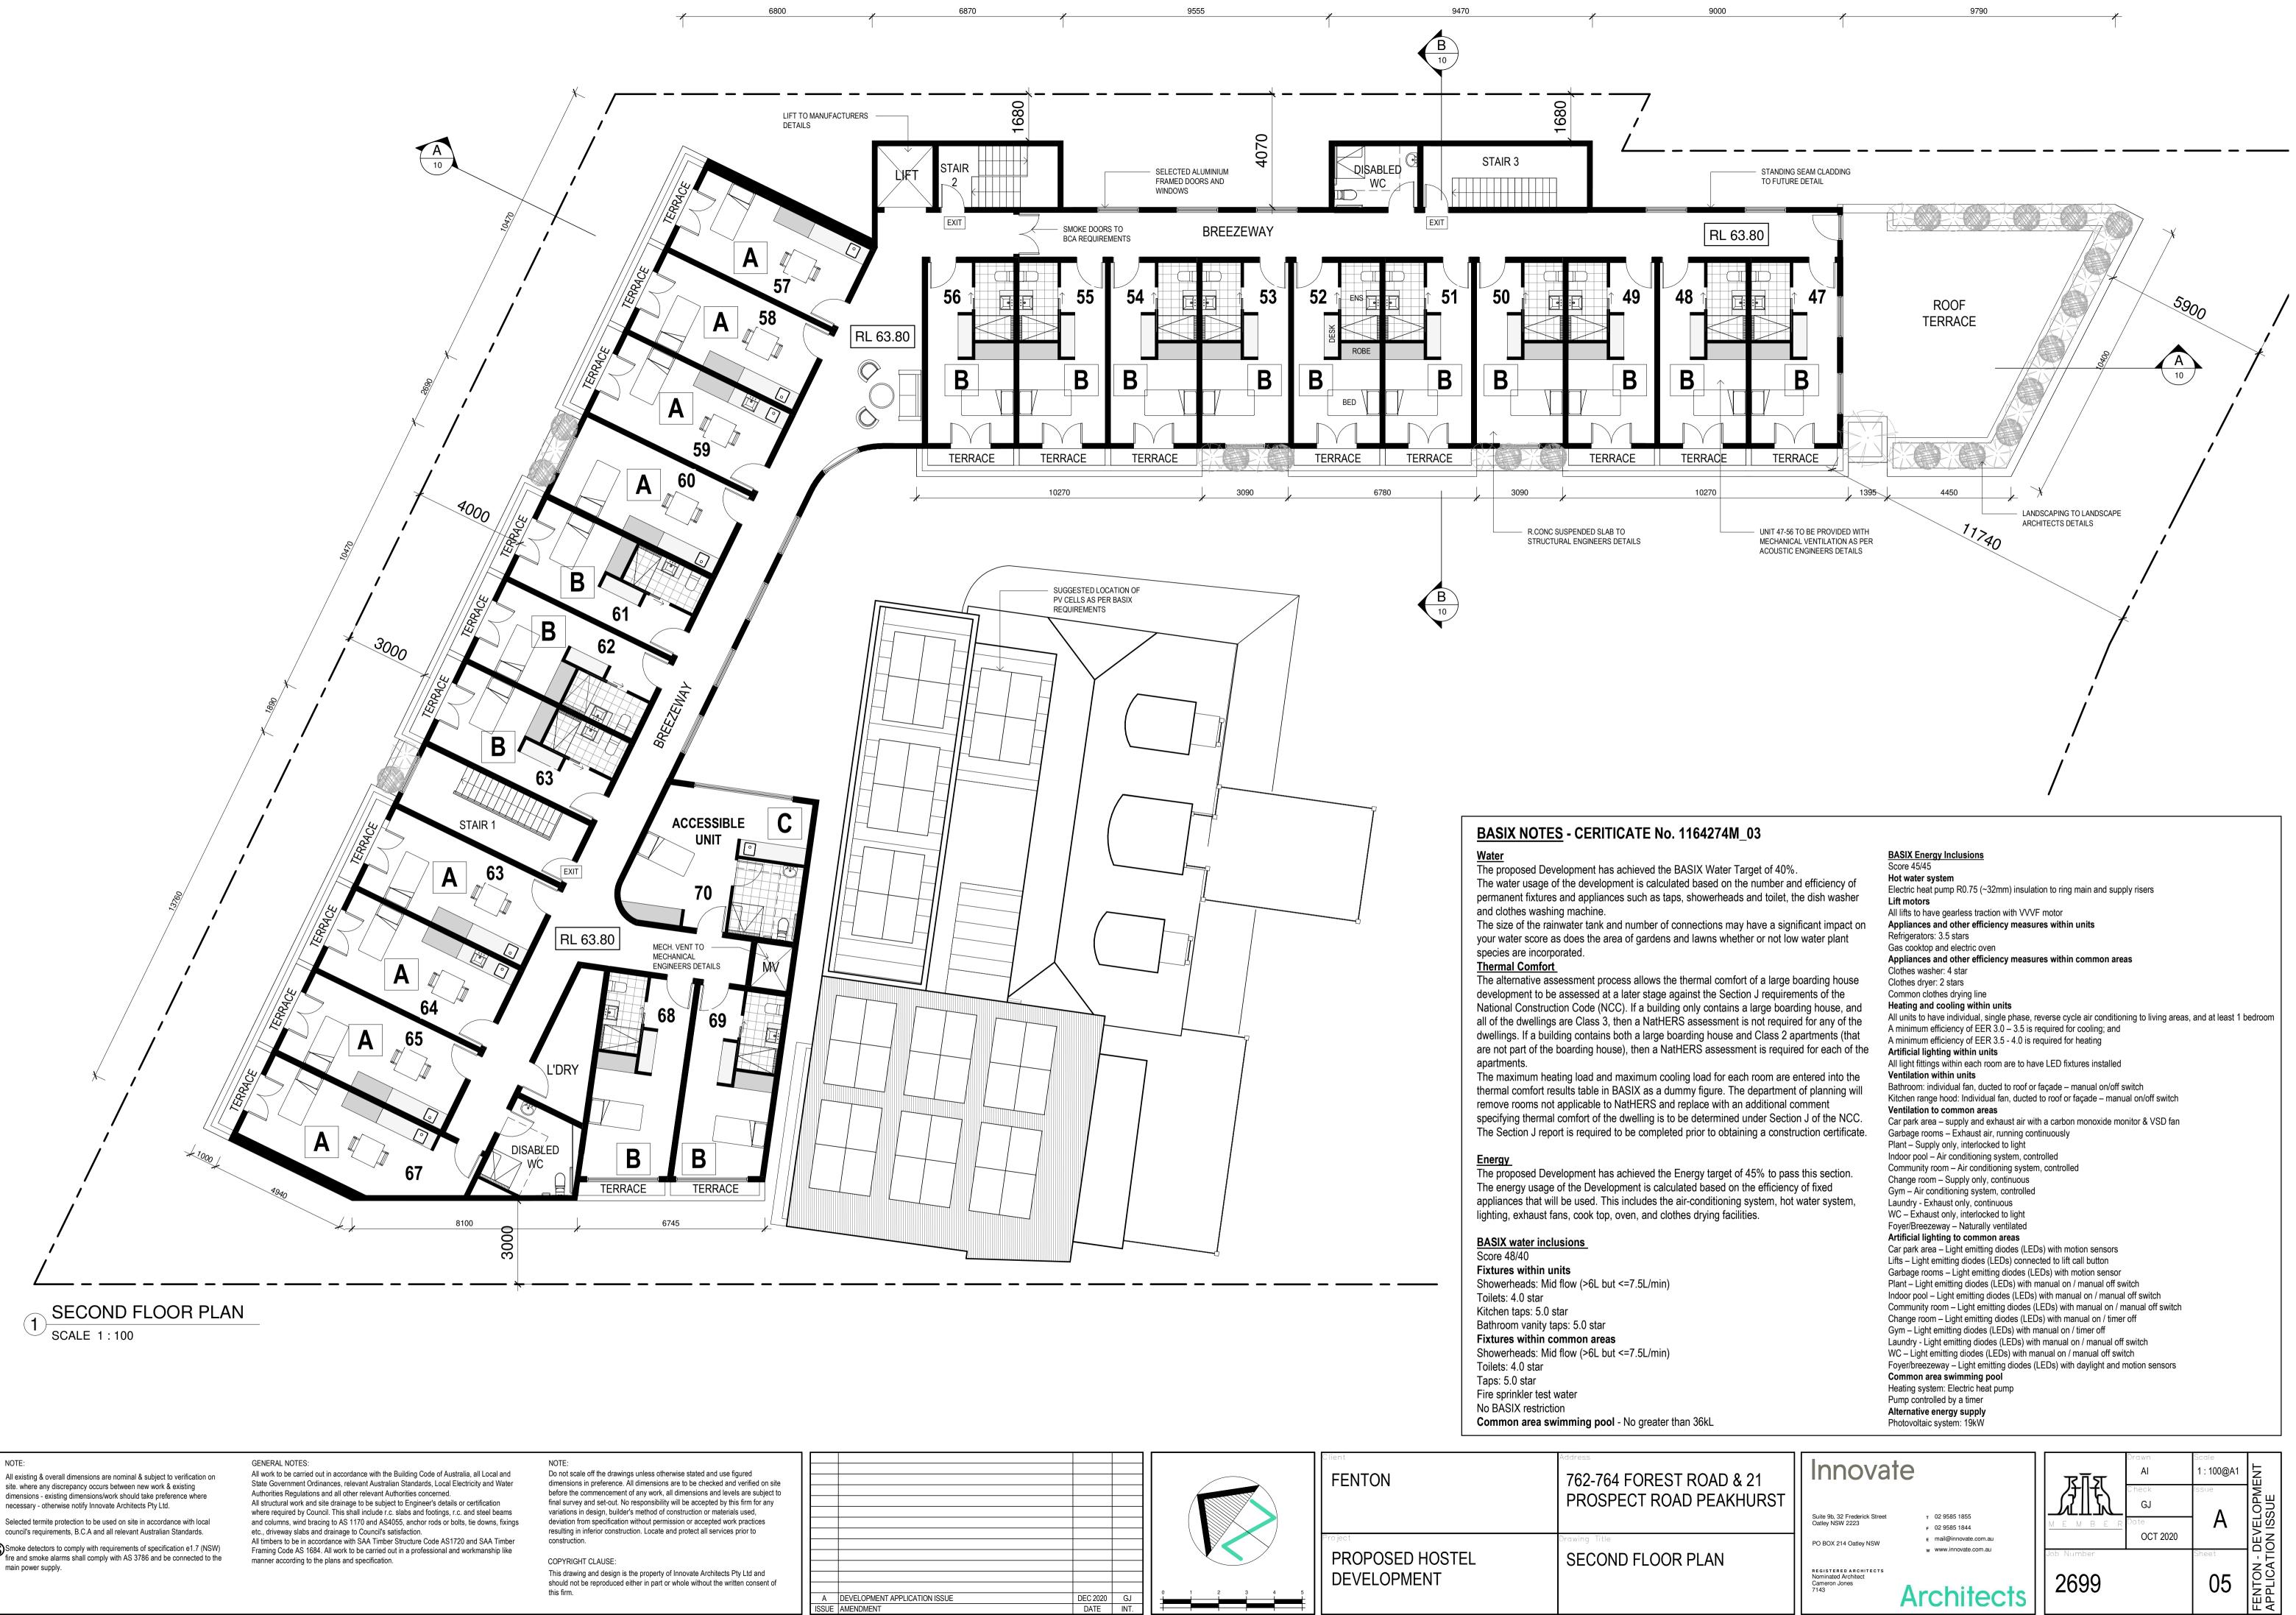
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A DEVELOPMENT APPLICATION ISSUE ISSUE AMENDMENT

DEVELOPMENT	

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& 21 KHURST	Suite 9b, 32 Frederick Str Oatley NSW 2223	reet T 02 9585 1855 F 02 9585 1844 A B E R Date A Just A B C R						
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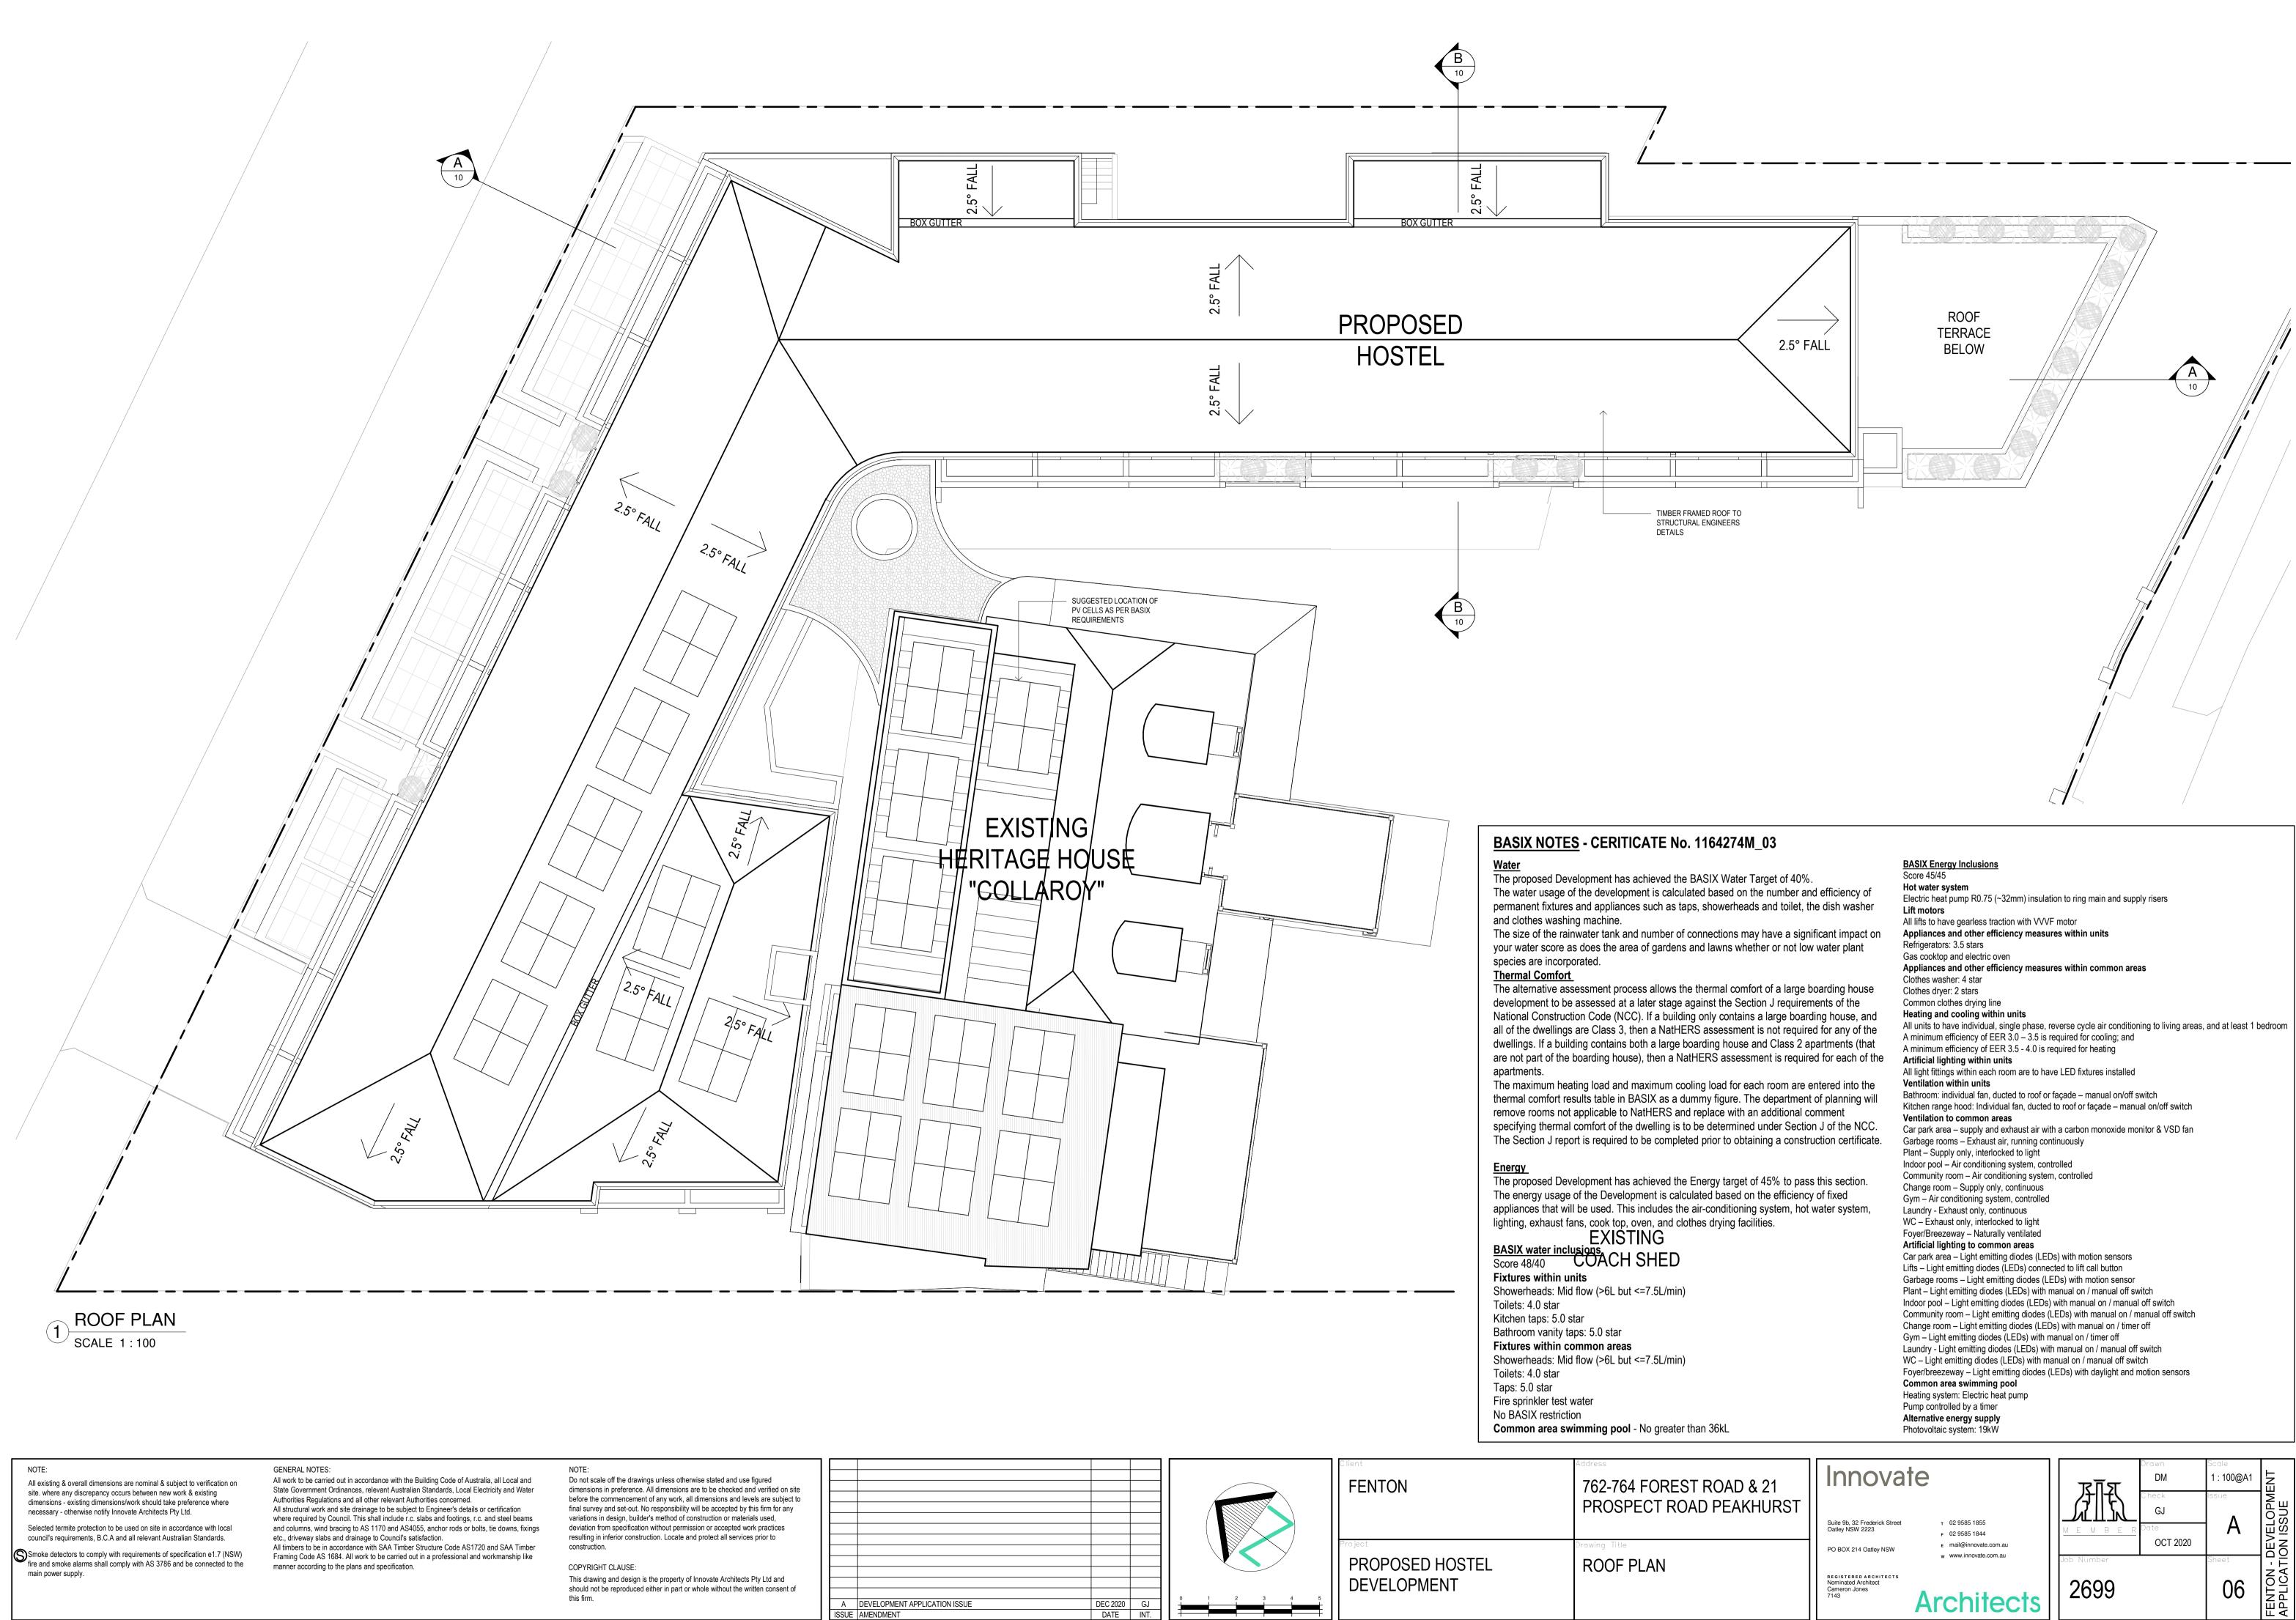
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		Common area swimming pool
		Heating system: Electric heat pump
		Pump controlled by a timer
		Alternative energy supply
		Photovoltaic system: 19kW
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			Client	Address
			I FENTON	762-764 FOREST ROAD
				PROSPECT ROAD PEAK
			Project	Drawing Title
				brawing inte
			PROPOSED HOSTEL	ELEVATIONS
				ELEVATIONS
			DEVELOPMENT	
VELOPMENT APPLICATION ISSUE	DEC 2020	GJ		
ENDMENT	DATE	INT		





## 2 NORTH EAST ELEVATION SCALE 1:100

🛨 RL 63.80 SECOND F

GROUND FL

RL 55.00 BASEMENT FL

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### NOTE:


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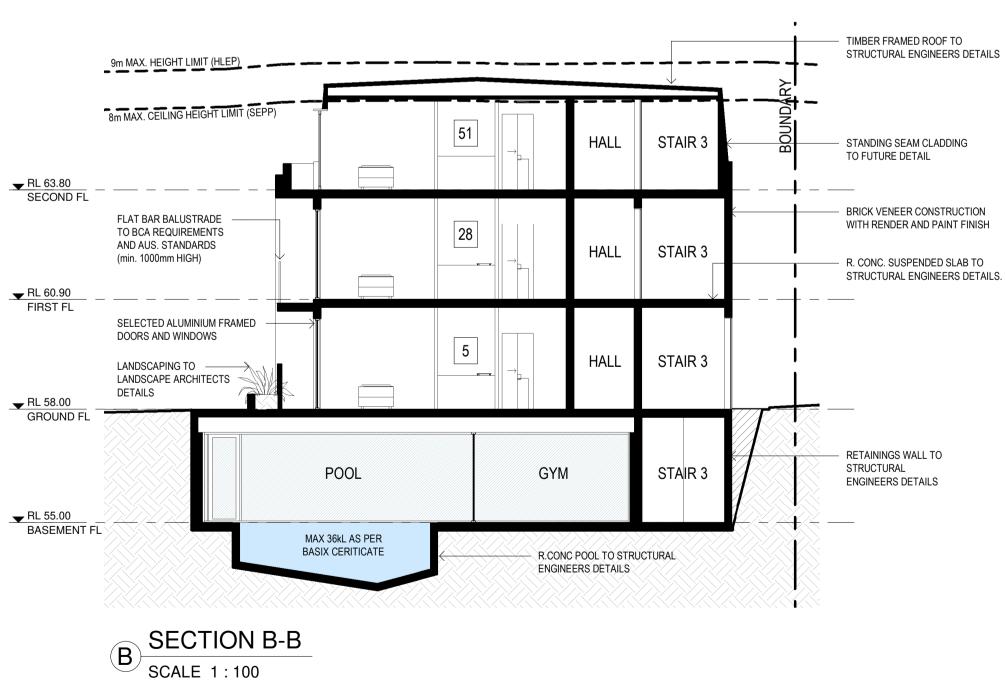
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A C ISSUE AN

		FENTON	762-764 FOREST ROAD & 21 PROSPECT ROAD PEAKHURST	Suite 9b, 32 Frederick Street Oatley NSW 2223         T         02 9585 1855 F         02 9585 1844		Check Is GJ Date		/ELOPMENT ISSUE
VELOPMENT APPLICATION ISSUE ENDMENT	DEC 2020 GJ DATE INT.	Project PROPOSED HOSTEL DEVELOPMENT	Drawing Title ELEVATIONS	PO BOX 214 Oatley NSW E mail@innovate.com.au w www.innovate.com.au REGISTERED ARCHITECTS Nominated Architect Cameron Jones 7143 Architects	Job Number 2699	OCT 2020	neet	FENTON - DEV APPLICATION





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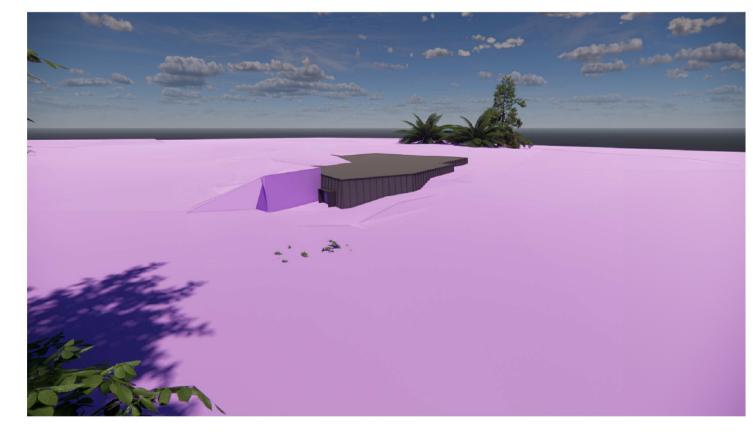
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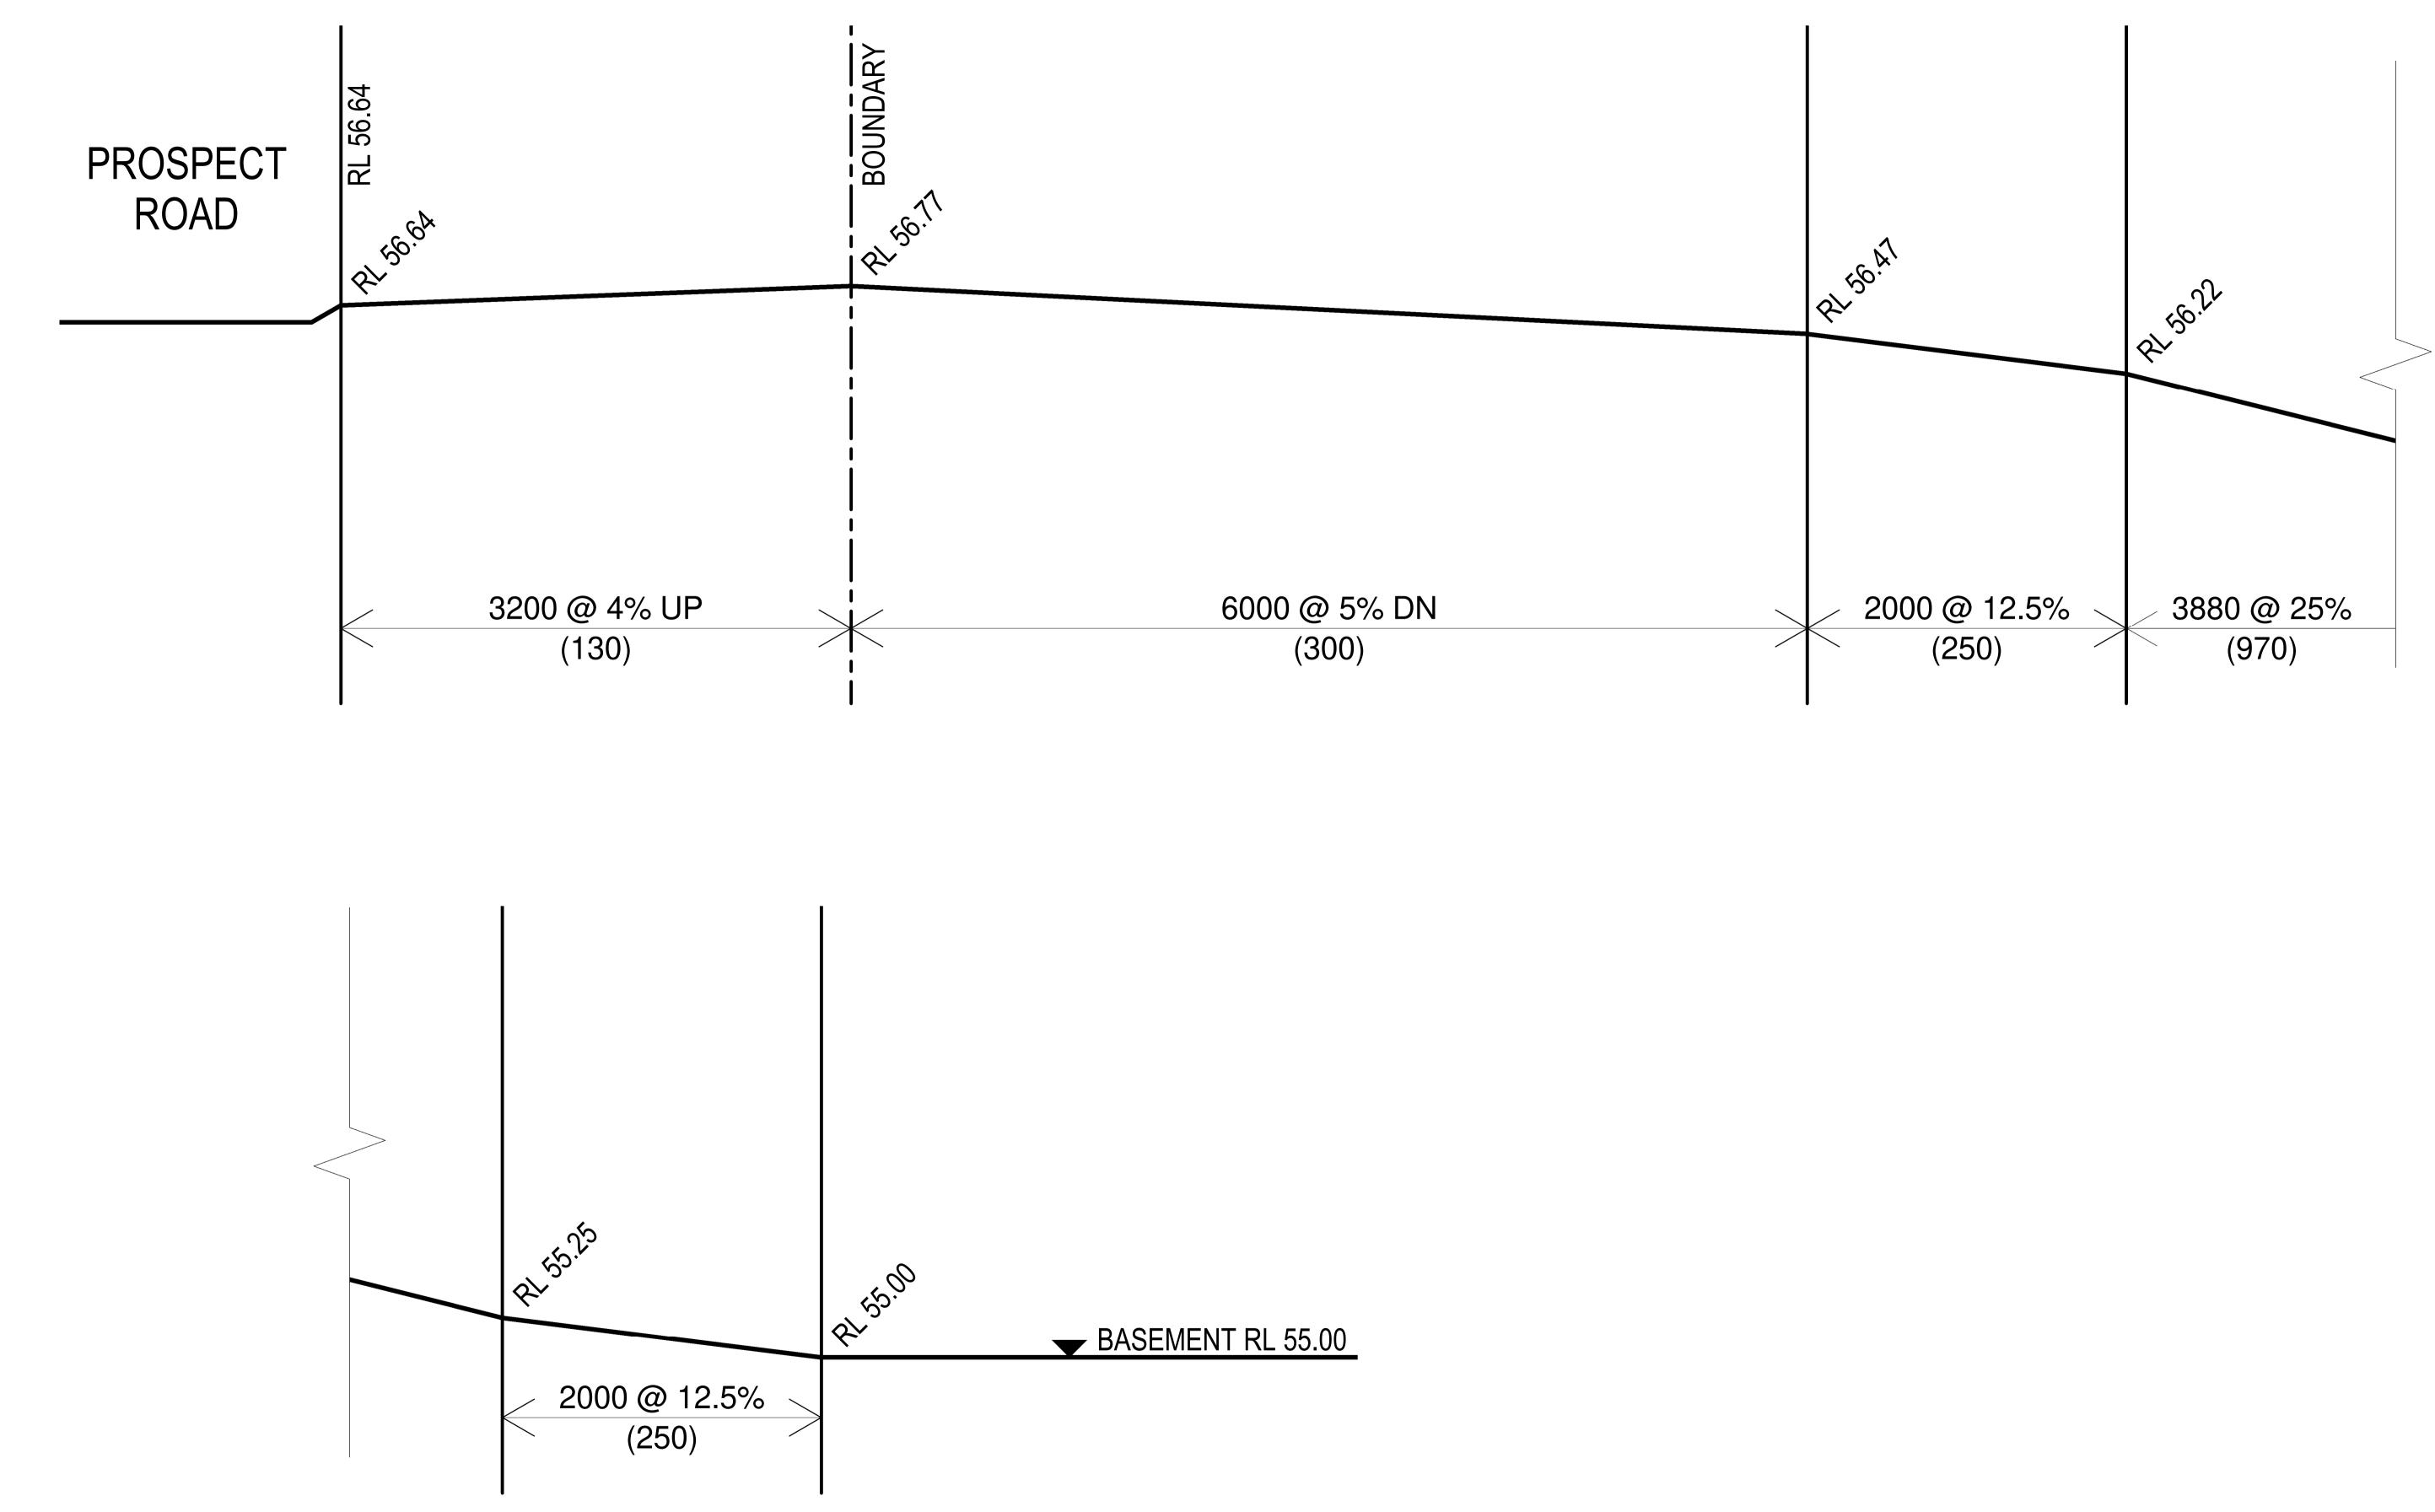


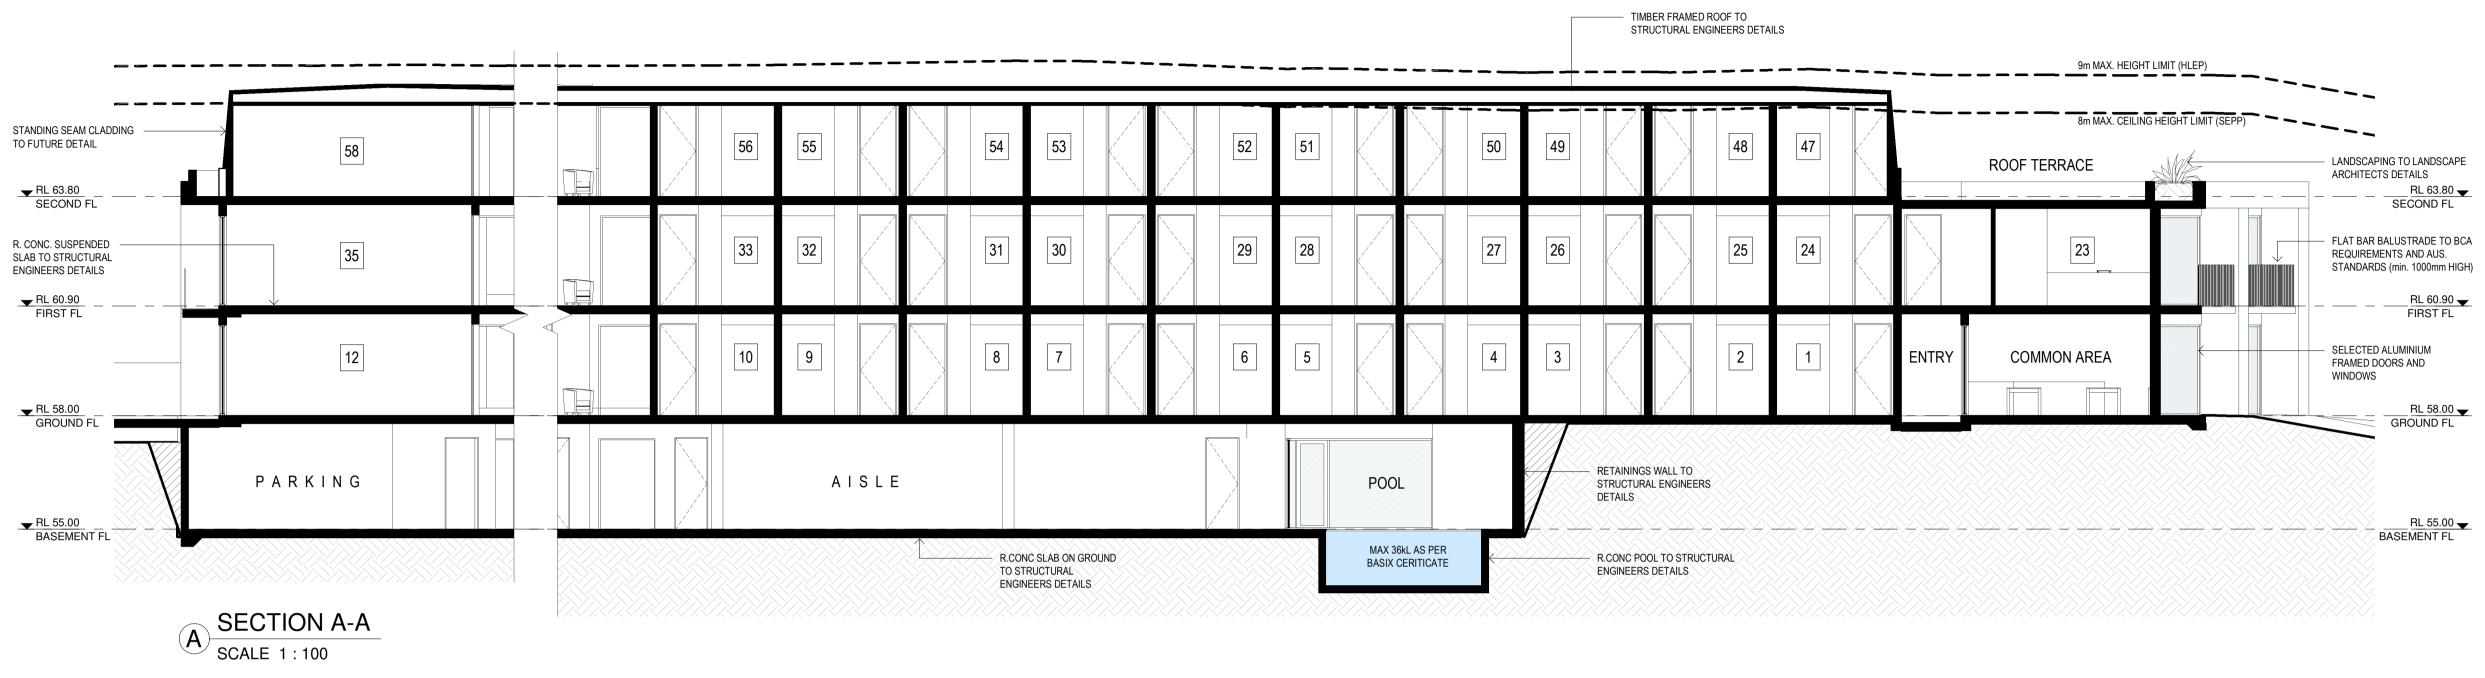8m SEPP MAX. CEILING HEIGHT DIAGRAM

		FENTON	Address 762-764 FOREST ROAD &
			PROSPECT ROAD PEAK
			Drawing Title
		PROPOSED HOSTEL	SECTIONS
A DEVELOPMENT APPLICATION ISSUE ISSUE AMENDMENT	DEC 2020 G. DATE INT		

9m HLEP MAX. HEIGHT DIAGRAM





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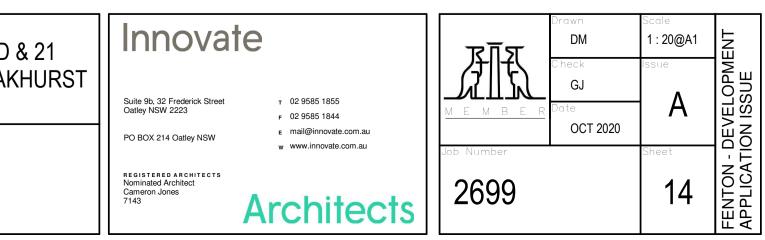
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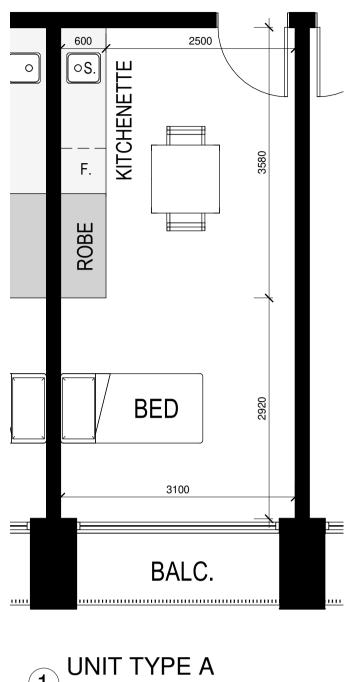
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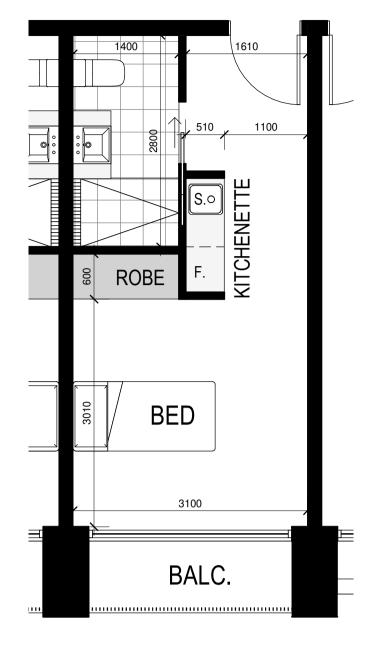
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						FENTON	762-764 FOREST ROAD 8
						FENTON	
							PROSPECT ROAD PEAK
						Project	Drawing Title
						PROPOSED HOSTEL	DRIVEWAY SECTION
						DEVELOPMENT	(INTERNAL KERB)
	A DEVELOPMENT APPLICATION ISSUE	DEC 2020	GJ	0	0 0.2 0.4 0.6 0.8 1		
IS	SUE AMENDMENT	DATE	INT.	I L∓			









BATH Ñ BED BALC **KITCHENETTE** 6085 UNIT TYPE D

SCALE 1:50



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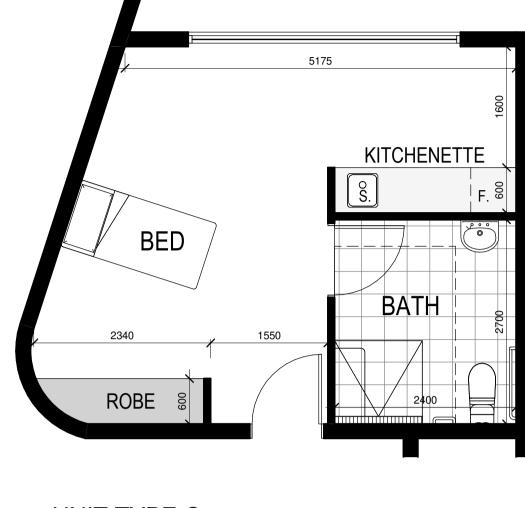
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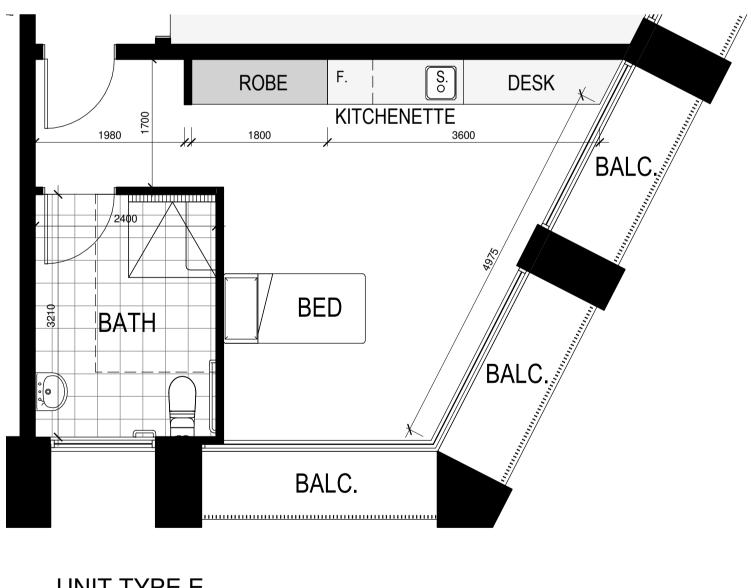
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ISSUE AM





(3) UNIT TYPE C SCALE 1:50



5 UNIT TYPE E SCALE 1:50

		FENTON	762-764 FOREST ROAD & PROSPECT ROAD PEAKH
DEVELOPMENT APPLICATION ISSUE	DEC 2020 GJ DATE INT.	Project PROPOSED HOSTEL DEVELOPMENT	Drawing Title TYPICAL ROOM LAYOUTS

### BASIX NOTES - CERITICATE No. 1164274M\_03

The proposed Development has achieved the BASIX Water Target of 40%.

The water usage of the development is calculated based on the number and efficiency of permanent fixtures and appliances such as taps, showerheads and toilet, the dish washer and clothes washing machine.

The size of the rainwater tank and number of connections may have a significant impact on your water score as does the area of gardens and lawns whether or not low water plant species are incorporated.

### Thermal Comfort

The alternative assessment process allows the thermal comfort of a large boarding house development to be assessed at a later stage against the Section J requirements of the National Construction Code (NCC). If a building only contains a large boarding house, and all of the dwellings are Class 3, then a NatHERS assessment is not required for any of the dwellings. If a building contains both a large boarding house and Class 2 apartments (that are not part of the boarding house), then a NatHERS assessment is required for each of the apartments.

The maximum heating load and maximum cooling load for each room are entered into the thermal comfort results table in BASIX as a dummy figure. The department of planning will remove rooms not applicable to NatHERS and replace with an additional comment specifying thermal comfort of the dwelling is to be determined under Section J of the NCC. The Section J report is required to be completed prior to obtaining a construction certificate.

### <u>Energy</u>

The proposed Development has achieved the Energy target of 45% to pass this section. The energy usage of the Development is calculated based on the efficiency of fixed appliances that will be used. This includes the air-conditioning system, hot water system, lighting, exhaust fans, cook top, oven, and clothes drying facilities.

BASIX water inclusions Score 48/40 Fixtures within units Showerheads: Mid flow (>6L but <=7.5L/min) Toilets: 4.0 star Kitchen taps: 5.0 star Bathroom vanity taps: 5.0 star Fixtures within common areas Showerheads: Mid flow (>6L but <=7.5L/min) Toilets: 4.0 star Taps: 5.0 star Fire sprinkler test water No BASIX restriction **Common area swimming pool** - No greater than 36kL **BASIX Energy Inclusions** Score 45/45 Hot water system Electric heat pump R0.75 (~32mm) insulation to ring main and supply risers Lift motors All lifts to have gearless traction with VVVF motor Appliances and other efficiency measures within units Refrigerators: 3.5 stars Gas cooktop and electric oven Appliances and other efficiency measures within common areas Clothes washer: 4 star Clothes dryer: 2 stars Common clothes drying line Heating and cooling within units All units to have individual, single phase, reverse cycle air conditioning to living areas, and at least 1 bedroom A minimum efficiency of EER 3.0 – 3.5 is required for cooling; and A minimum efficiency of EER 3.5 - 4.0 is required for heating Artificial lighting within units All light fittings within each room are to have LED fixtures installed Ventilation within units Bathroom: individual fan, ducted to roof or façade – manual on/off switch Kitchen range hood: Individual fan, ducted to roof or façade – manual on/off switch Ventilation to common areas Car park area – supply and exhaust air with a carbon monoxide monitor & VSD fan Garbage rooms – Exhaust air, running continuously Plant – Supply only, interlocked to light Indoor pool – Air conditioning system, controlled Community room – Air conditioning system, controlled Change room – Supply only, continuous Gym – Air conditioning system, controlled Laundry - Exhaust only, continuous WC - Exhaust only, interlocked to light Foyer/Breezeway – Naturally ventilated Artificial lighting to common areas Car park area – Light emitting diodes (LEDs) with motion sensors Lifts – Light emitting diodes (LEDs) connected to lift call button Garbage rooms – Light emitting diodes (LEDs) with motion sensor Plant – Light emitting diodes (LEDs) with manual on / manual off switch Indoor pool – Light emitting diodes (LEDs) with manual on / manual off switch Community room - Light emitting diodes (LEDs) with manual on / manual off switch Change room – Light emitting diodes (LEDs) with manual on / timer off Gym – Light emitting diodes (LEDs) with manual on / timer off Laundry - Light emitting diodes (LEDs) with manual on / manual off switch WC – Light emitting diodes (LEDs) with manual on / manual off switch Foyer/breezeway – Light emitting diodes (LEDs) with daylight and motion sensors Common area swimming pool Heating system: Electric heat pump Pump controlled by a timer Alternative energy supply Photovoltaic system: 19kW


21	Innovate	Drawn DM Check	Scale 1:50@A1
HURST	Suite 9b, 32 Frederick Street т 02 9585 1855 Oatley NSW 2223 F 02 9585 1844 PO BOX 214 Oatley NSW E mail@innovate.com.au	GJ M E M B E R Date OCT 2020	
S	REGISTERED ARCHITECTS Nominated Architect Cameron Jones 7143 Architects	Job Number 2699	Sheet 13 BENTON - D APPLICATIC





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Smoke detectors to comply with requirements of specification e1.7 (NSW)

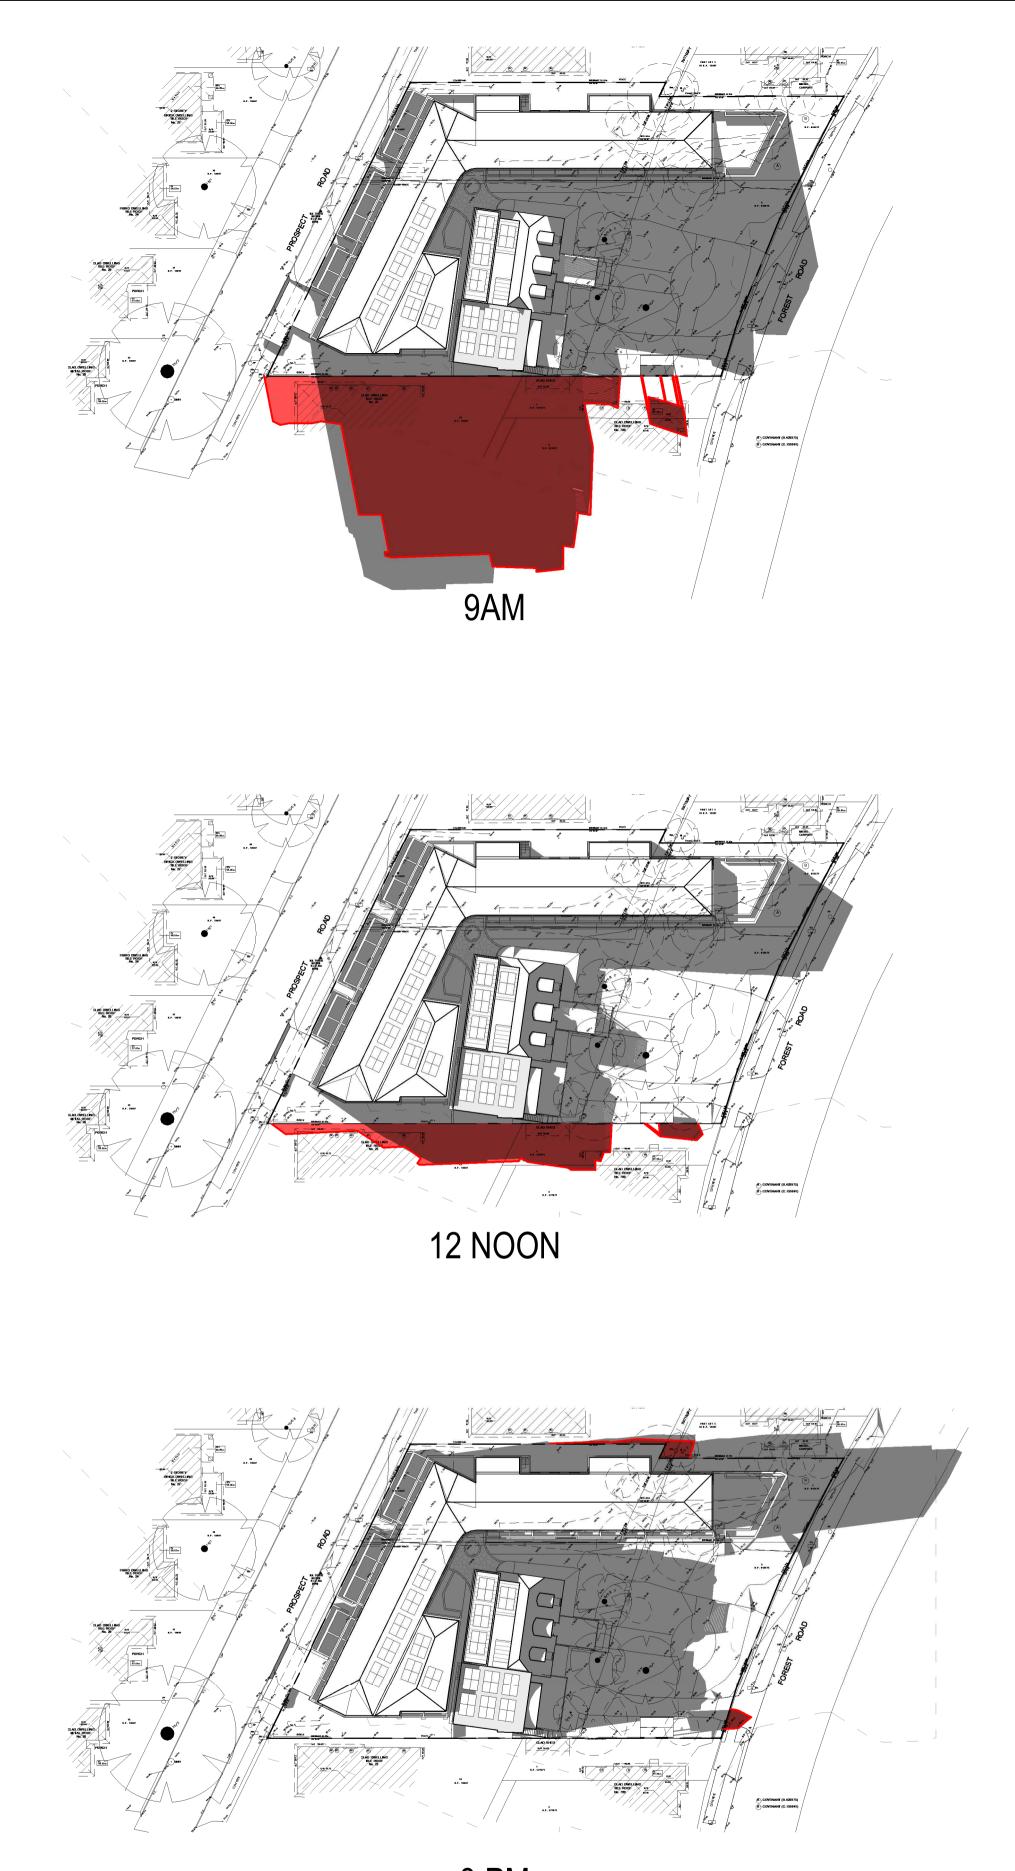

## 3 PM WINTER SOLSTICE (JUNE 21)

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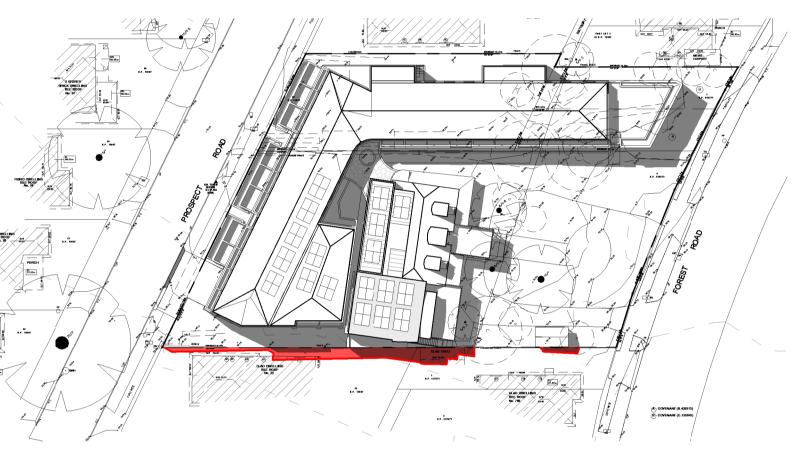
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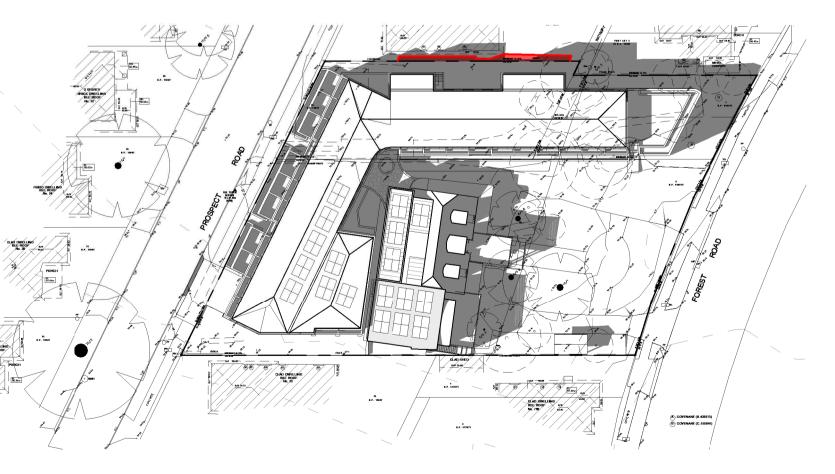
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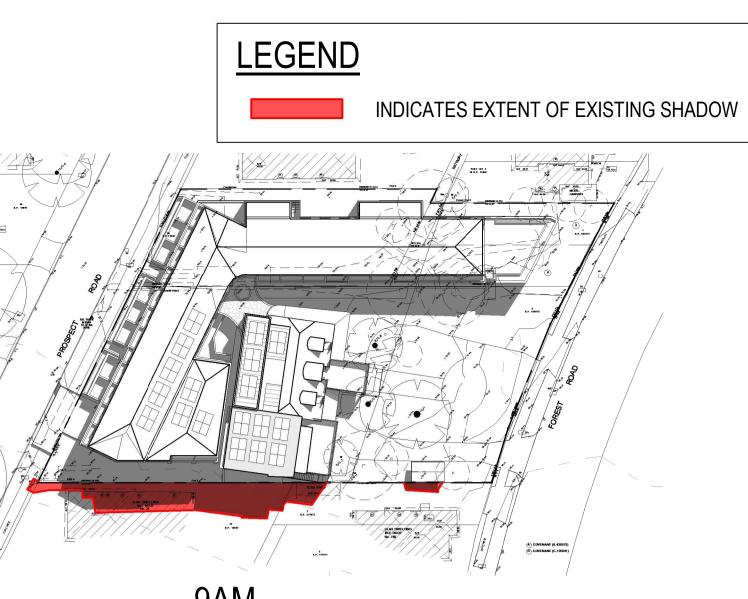
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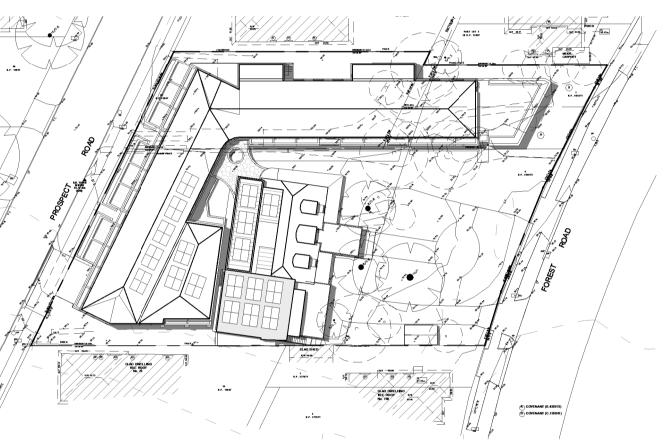
3 PM EQUINOX (SEPT 21)

te to					FENTON	762-764 FOREST ROAD 8 PROSPECT ROAD PEAK
		A DEVELOPMENT APPLICATION ISSUE	DEC 2020	GJ	Project PROPOSED HOSTEL DEVELOPMENT	Drawing Title SHADOW DIAGRAMS
	ISS	UE AMENDMENT	DATE	INT.		


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## 3 PM SUMMER SOLSTICE (DEC 21)

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	Suite 9b, 32 Frederick Street Oatley NSW 2223 PO BOX 214 Oatley NSW	т 02 9585 1855 г 02 9585 1844 в mail@innovate.com.au	M E M B E R Date OCT 2020		A	DN ISSUE
	REGISTERED ARCHITECTS Nominated Architect Cameron Jones 7143	Architects	Job Number 2699		Sheet <b>11</b>	FENTON - D APPLICATIO


## Innovate

EXTERNAL FINISHES

762-764 Forest Road, Peakhurst FENTON DEC 2020

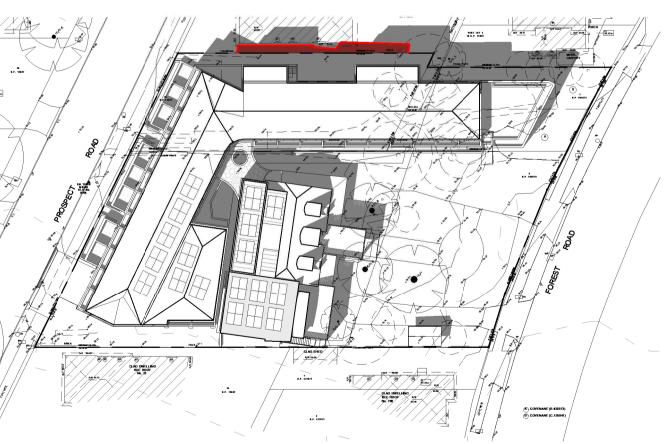
## Making the new.



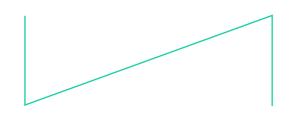

DEVELOPMENT APPLICATION 762-764 Forest Road, Peakhurst PERSPECTIVE VIEW



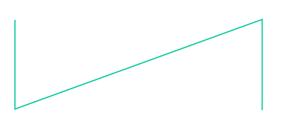

DEVELOPMENT APPLICATION 762-764 Forest Road, Peakhurst EXTERNAL FINISHES

